GENERAL NOTES

THE FOLLOWING NOTES SHALL APPLY THROUGHOUT. EXCEPTIONS ARE SPECIFICALLY NOTED ON EACH DRAWINGS.

- ALL WORK OF THIS CONTRACT SHALL BE DONE IN ACCORDANCE WITH THE LATEST EDITION OF THE INTERNATIONAL BUILDING CODE WITH DISTRICT OF COLUMBIA AMMENDMENTS AND REGULATIONS OF OTHER AGENCIES HAVING JURISDICTION ON THE WORK OF THIS CONTRACT.
- DRAWINGS ARE NOT TO BE SCALED. USE DIMENSIONS ONLY. ALL DIMENSIONS AND CONDITIONS SHOWN AND ASSUMED ON THE DRAWINGS MUST BE VERIFIED AT THE SITE BY THE CONTRACTOR BEFORE ORDERING ANY MATERIAL OR DOING ANY WORK. ANY DISCREPANCIES IN THE DRAWINGS AND SPECIFICATIONS SHALL BE REPORTED TO THE AOR. NO CHANGE IN DRAWINGS OR SPECIFICATIONS IS PERMISSIBLE WITHOUT THE WRITTEN CONSENT OF THE ARCHITECT/ENGINEER. NO WORK SHALL PROCEED UNTIL SUCH DISCREPANCY HAS BEEN RECTIFIED.
- ALL WORK ON THESE DRAWINGS SHALL BE CONSIDERED NEW WORK WHETHER STATED OR NOT EXCEPT WHERE SPECIFICALLY NOTED AS "EXISTING".
- COORDINATION OF ALL WORK UNDER THIS CONTRACT SHALL BE MAINTAINED TO ENSURE THE QUALITY AND TIMELY COMPLETION OF THE WORK/PROJECT.
- THE CONTRACTOR SHALL DISCONNECT AND/OR REMOVE ANY EXISTING PLUMBING, ELECTRICAL FIXTURES, WIRE CONDUITS, OR OTHER WORK WHICH MIGHT INTERFERE WITH THE WORK OF THIS CONTRACT. AFTER NEW WORK IS COMPLETED, THE DISCONNECTED OR REMOVED ITEMS SHALL BE REINSTALLED BY THE CONTRACTOR AT THE SAME LOCATION OR AT NEW LOCATION AS DIRECTED. FURNISH ALL NECESSARY NEW MATERIALS/HARDWARE FOR COMPLETION OF WORK.
- THE CONTRACTOR SHALL PATCH AND REPAIR ALL DAMAGED OR EXPOSED SURFACES DUE TO CONTRACT WORK. ALL NEWLY INSTALLED, PATCHED WORK AND ALL AFFECTED AREAS SHALL BE PAINTED. ALL PAINTING WORK SHALL BE PERFORMED TO COVER THE ENTIRE HORIZONTAL OR VERTICAL SURFACE TO THE CLOSEST CORNER IN ALL FOUR DIRECTIONS. COLOR TO MATCH EXISTING CONDITIONS.
- THE CONTRACTOR SHALL FURNISH AND INSTALL NEW MATERIALS AT NO ADDITIONAL COST TO THE OWNER FOR THE FOLLOWING CONDITIONS: a) ANY EXISTING WORK THAT HAS BEEN REMOVED OR DAMAGED IN ORDER TO PERFORM THE CONTRACT WORK. b) TO FURNISH THE WORK OF THIS CONTRACT IN WORKMANLIKE MANNER.
- THE CONTRACTOR SHALL BE RESPONSIBLE FOR ADEQUATELY BRACING AND PROTECTING ALL WORK DURING CONSTRUCTION AGAINST DAMAGE, BREAKAGE, COLLAPSE, DISTORTIONS AND OFF ALIGNMENTS ACCORDING TO CODES AND STANDARDS OF GOOD
- THE CONTRACTOR SHALL INCLUDE ALL PREPATORY AND ASSOCIATED SUPPLEMENTARY WORK TO PROVIDE A COMPLETE AND FINISHED INSTALLATION.
- 10. WHERE MANUFACTURER'S NAMES AND PRODUCT NUMBERS ARE INDICATED ON DRAWINGS, IT SHALL MEAN THE BASIS OF DESIGN. ALL OTHER PRODUCTS MUST BE SUBMITTED TO THE AOR.
- 11. SIZE OF MASONRY UNITS AND WOOD MEMBERS ON PLANS. BUILDING ELEVATIONS AND SECTIONS ARE SHOWN AS NOMINAL SIZE.
- 12. THE CONTRACTOR SHALL KEEP WORK SITE FREE FROM DEBRIS AND ACCUMULATED REFUSE, AND SHALL HAVE SOLE RESPONSIBILITY FOR PROTECTING ALL DANGEROUS AREAS FROM ENTRY BY UNAUTHORIZED PARTIES. SITE SHALL BE LEFT BROOM CLEAN AT THE
- 13. THE CONTRACTOR SHALL MAINTAIN FREE AND UNOBSTRUCTED ACCESS FROM ALL ADJACENT SPACES INTO THE EXISTING EGRESS STAIRS TO OUTSIDE OF THE BUILDING AT ALL TIMES.
- 14. WHERE INDICATED OR REQUIRED TO PERFORM THE WORK. PACK, PROTECT AND RELOCATE FURNITURE, CABINETS, ETC. TO OWNER DESIGNATED LOCATIONS AND RETURN ITEMS UPON COMPLETION OF WORK.
- 15. WORK NOT MATCHING THE CONTRACT DOCUMENTS IS SUBJECT TO DISAPPROVAL BY THE OWNER, AOR OR EOR AND CONTRACTOR IS FULLY RESPONSIBLE FOR CORRECTIVE WORK UNTIL WORK MATCHES THE CONTRACT DOCUMENTS.
- 16. ALL CHANGES TO THE CONTRACT DOCUMENTS ARE TO BE APPROVED BY THE OWNER/AOR/EOR PRIOR TO CONSTRUCTION.

BUILDING CODE NOTES

THIS PROJECT INCLUDES REPLACEMENT OF ROOFING, REPAIR OF AN EXISTING STAIR BULKHEAD, AND INSTALLATION OF A GREEN ROOF SYSTEM.

THE EXISTING STAIR ACCESS TO THE ROOF WAS CONSTRUCTED AS A NON-FILED PROJECT AND IS NOT IN COMPLIANCE WITH APPLICABLE CODES. THIS PROJECT BRINGS THE STAIR TO THE SAME LEVEL OF PROTECTION AS THE REST OF THE HOME.

THE EXISTING STAIR BETWEEN THE SECOND FLOOR AND ROOF IS EXTREMELY STEEP. THIS PROJECT WILL REPLACE THIS STAIR WITH A STAIR MATCHING THE SLOPE OF THE EXISTING STAIR BETWEEN THE FIRST AND SECOND FLOORS, REFER TO A202 FOR A STAIR

THE EXISTING HOME IS A TRADITIONAL ROW HOUSE FROM THE 1890'S. WITH TWO STORIES AND A BASEMENT.

APPLICABLE CODES:

2012 INTERNATIONAL RESIDENTIAL CODE 2012 INTERNATIONAL ELECTRICAL CODE 2012 INTERNATIONAL PLUMBING CODE

THIS IS A NON-SPRINKLERED BUILDING

STRUCTURAL LOADS - REFER TO S101.

THE PROJECT IS LOCATED IN CLIMATE ZONE 4

THIS PROJECT OCCURS ENTIRELY WITHIN THE FOOTPRINT OF THE EXISTING BUILDING. THERE IS NO ENLARGEMENT OF THE BUILDING FOOTPRINT. THE EXISTING FOOTPRINT IS ±670 SF.

FOR EXTERIOR WALL AND ROOF ASSEMBLY AND R VALUES REFER TO A201.

GREEN ROOF NOTES

THIS PROJECT HAS APPLIED FOR INCLUSON IN THE RIVER SMART

HISTORIC NOTES


THIS PROJECT IS IN THE CAPITOL HILL HISTORIC DISTRICT. REFER

TO A001 & A002 FOR NOTES APPLICABLE TO THE HISTORIC

ROOFTOPS PROGRAM.

REGULATIONS.

SYMBOLS

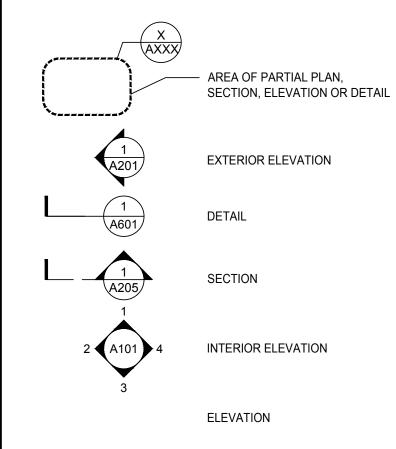

INSUL.

INSULATION

KEYNOTE

ABBREVIATIONS

LIST OF DRAWINGS

TITLE, NOTES, ABBREVIATIONS **ZONING NOTES & MATERIAL SPECIFICATIONS** T002 D101 **DEMOLITION PLANS & SPECIFICATIONS** HISTORIC VIEWSHED COMPLIANCE A001 A002 HISTORIC VIEWSHED COMPLIANCE A101 SECOND FLOOR & MEZZANINE PLANS A102 ROOF DECK PLAN & ROOF PLAN A103 REFLECTED CEILING PLAN A201 **ELEVATIONS AND DETAILS** A202 **SECTIONS** A203 DETAILS

S001 STRUCTURAL NOTES, LOADS AND SPECIAL INSPECTIONS S101 SECOND FLOOR, STAIR LANDING & ROOF FRAMING PLANS

S102 **ROOF DECK & ROOF FRAMING PLANS** STRUCTURAL DETAILS S103

ALTERNATES

PROVIDE AN ITEMIZED PRICE AND DEFER TO OWNER'S CHOICE ON THE FOLLOWING ITEMS:

- CONCEALED NATURAL GAS LINE EXTENSION TO ROOF FOR GRILL AND FIRE TABLE, WITH NATURAL GAS CONVERSION KIT FOR EACH, IN LIEU OF
- FOR SLIDING DOOR PELLA ARCHITECT SERIES 850 CONTEMPORARY IN LIEU OF WESTERN WINDOWS SERIES 7650 SLIDING GLASS DOOR WITH INSULATED GLAZING, LOW-E COATING AND A THERMALLY BROKEN FRAME. PELLA DOOR TO MATCH AS MANY PERFORMANCE SPECIFICATIONS OF WESTERN WINDOWS 7650 AS FEASIBLE. BASE CONTRACT IS WESTERN WINDOWS 7650.
- 3. EXTERIOR GRADE WAP MOUNTED IN A CONCEALED LOCATION IN LIFTUOE OWNER PROVIDED, CONTRACTOR INSTALLED WIRELESS EXTENDERS.
- 4. PRIMED AND PAINTED STEEL IN LIEU OF GALVANIZED STEEL FOR ALL STEEL EXPOSED TO THE ELEMENTS.

5)(0)

ARCHITECTURE FOREVER

4500 East West Highway #125 Bethesda, MD 20814 (240) 760-1037

NOTE: Drawing may be printed at reduced scale

DRAFT - NOT FOR CONSTRUCTION

DATE REV No. Date Revision Key Plan PROJECT — LINCOLN E CAPITOL ST **CLUSTER 26** WARD 6

EOR: JAMES GEORGE KONNICK PE AOR: CLAIR M. WHOLEAN AIA LEED AP BD+C

Project No. 2018-001

09/17/2018

Project:

ROOF REPLACEMENT WITH GREEN ROOF

Address: 16 10TH ST NE WASHINGTON DC 20002

Drawing Title:

TITLE, NOTES **ABBREVIATIONS** AND SPECIFICATIONS

Drawing No.:

T101.00

Sheets in DOB Set: 01 of 17

Sheets in Contract Set: 01 of 17

ZONING NOTES

ZONE

PROJECT IS IN ZONE RF-1.

BUILDING HEIGHT

THE EXISTING BUILDING IS 32'-7" ABOVE GRADE MEASURED FROM THE MIDPOINT OF THE FRONT FACADE, IN COMPLIANCE WITH 303.1.

LOT OCCUPANCY LOT AREA = 880 SF BUILDING FOOTPRINT = 668

BUILDING FOOTPRINT = 668 SF LOT OCCUPANCY = 76%

FLOOR AREA RATIO

GROSS FLOOR AREA = 2004 SF (INCLUDING BASEMENT) FAR = 2.3

YARD:

FRONT AND REAR YARDS ARE NOT MODIFIED BY THIS PROJECT. THERE ARE NO SIDE YARDS APPLICABLE TO ROW HOUSES ON AN INTERIOR LOT.

ORIGINAL ROOFTOP ELEMENTS

THE ONLY ORIGINAL ROOFTOP ELEMENT IS AN EXISTING CHIMNEY AND IT IS NOT ALTERED BY THIS PROJECT. THIS PROJECT IS IN COMPLIANCE WITH 206.1.

PENTHOUSE

THIS PROJECT INCLUDES STAIR ACCESS TO THE ROOF. THE STAIR ENCLOSURE FALLS UNDER THE CRITERIA OF PENTHOUSE PER CHAPTER 15, 1500.3 AND IS PROVIDED SOLELY FOR ROOF ACCESS, NOT HABITABLE SPACE.

PENTHOUSE APPLICABILITY

ON ROWHOUSES, A PENTHOUSE IS ALLOWABLE AS A SPECIAL EXCEPTION PER 1500.4 THAT CONTAINS ONLY STAIR ACCESS TO THE ROOF AND IS NO MORE THAN 10-0" HIGH. THIS PENTHOUSE CONSISTS ONLY OF A STAIR AND HAS NO STORAGE AND NO OCCUPIED SPACE.

PENTHOUSE HEIGHT

THE STAIR ENCLOSURE IS IN COMPLIANCE WITH 1500.4 IN THAT IT RISES 9' 10 1/2" ABOVE THE EXISTING ROOF HIGH POINT (10'-0" ALLOWED) AND IS ONE STORY.

THE STAIR ENCLOSURE IS IN COMPLIANCE WITH SPECIAL EXCEPTION UNDER SUBTITLE X, CHAPTER 9 AND PENTHOUSE MAXIMUM HEIGHT OF 12'-0" PER 303.7.

PENTHOUSE WALLS

UNIFORM HEIGHT WALLS ARE REQUIRED PER 1500.9. THIS IS NOT FEASIBLE DUE TO HISTORIC VIEW REGULATIONS. THE STAIR ENCLOSURE HAS BEEN DESIGNED WITH A SLOPING ROOF TO BE OUT OF THE HISTORIC VIEW SHED.

PENTHOUSE SETBACKS

THE FRONT PENTHOUSE SETBACK IS 16'-6" FROM THE FRONT BUILDING WALL, IN COMPLIANCE WITH 1502.1a AS THIS IS GREATER THAN ITS HEIGHT OF 9'-10 1/2".

THE REAR PENTHOUSE SETBACK IS 6'-3". PER 1502.b THIS IS TO BE EQUAL TO THE PENTHOUSE HEIGHT. DUE TO THE HISTORIC VIEW REQUIREMENTS, COMPLIANCE WITH THIS SETBACK IS INFEASIBLE. THE SETBACK HAS BEEN MAXIMIZED TO THE GREATEST DEGREE POSSIBLE WHILE PROVIDING COMPLIANCE WITH HISTORIC REGULATIONS. THE SIZE OF THE PENTHOUSE HAS BEEN MADE AS SMALL AS POSSIBLE WHILE PROVIDING SAFE ROOF ACCESS.

PENTHOUSE SIDE SETBACK PER 1502.c IS NOT FEASIBLE FOR AN 18'-0" WIDE LOT. PLEASE NOTE THAT THE INTENT OF THE PENTHOUSE DESIGN IS TO PROVIDE SAFE ROOF ACCESS TO CORRECT THE NON-COMPLIANT CONSTRUCTION.

REFER TO 1504 RELIEF TO PENTHOUSE REQUIREMENTS:

- a. STRICT APPLICATION OF PENTHOUSE SIDE SETBACK WOULD BE UNDULY RESTRICTIVE.
- b. THE RELIEF REQUESTED RESULTS IN A BETTER DESIGN OF THE ROOF STRUCTURE WITHOUT APPEARING TO BE AN EXTENSION OF THE BUILDING WALL. THE STAIR ENCLOSURE IS NOT VISIBLE FROM THE STREET, IS CONSTRUCTED OF WOOD, AND IS STRUCTURALLY SEPARATE FROM THE MASONRY BEARING WALLS, THEREFORE IT IS NOT AN EXTENSION OF THE BUILDING WALL.
- c. THE STAIR ENCLOSURE IS NOT VISUALLY INTRUSIVE AS IT IS NOT VISIBLE FROM THE STREET.
- d. CONSTRUCTION CODE REASONABLE EFFICIENCIES IN LOWER FLOORS: THE STAIR HAS BEEN DESIGNED AS A CONTINUATION OF THE EXISTING STAIR. CREATING A SECOND STAIR IN A ROW HOUSE IS PRACTICALLY INFEASIBLE DUE TO THE NARROW WIDTH OF THE LOT.
- e. EVERY EFFORT HAS BEEN MADE TO BE IN COMPLIANCE WITH THE REQUIRED SETBACKS.
- THERE IS NO EFFECT TO THE LIGHT AND AIR OF ADJACENT STRUCTURES.

PENTHOUSE AREA

THE EXISTING PENTHOUSE IS 31 SF AND WILL BE REPLACED WITH A NEW PENTHOUSE THAT IS 85 SF. THIS IS 13% OF THE TOTAL ROOF AREA, IN COMPLIANCE WITH 1503.2.

THE NEW PENTHOUSE IS 85 SF AND IS 20% OF THE USABLE ROOFTOP SPACE, IN COMPLIANCE WITH 1500.3b.

TOTAL ROOF AREA: 668 SF USABLE ROOF AREA 434 SF (GREEN ROOF + WOOD DECK) PENTHOUSE AREA: 85 SF PROPERTY IDENTIFICATION: CLUSTER 26 WARD 6 SMD 6A03 CENSUS TRACT 008100 SSL 0941 0821 ANC 6A03

MATERIAL SPECIFICATIONS

THE FOLLOWING MATERIALS ARE THE BASIS OF DESIGN. ALL SUBSTITUTIONS MUST BE APPROVED BY THE OWNER AND THE AOR PRIOR TO INSTALLATION.

DIV 02

GREEN ROOF

BASIS OF DESIGN WHITE EPDM 45 MIL MINIMUM & EXTENSIVE 4" LAY-IN GREEN ROOF SYSTEM. GREEN ROOF SATURATED WEIGHT IS NOT TO EXCEED 30 PSI. EPDM ROOF MEMBRANE IS TO BE COMPATIBLE WITH GREEN ROOF SYSTEM AND IS TO BE SUITABLE FOR EXPOSURE TO THE ELEMENTS WITHOUT BALLAST.

DIV 04

GUARDRAIL: ATLANTIS SUN RAILLATITUDE (NOTE NO SUBSTITUTIONS FOR THIS PRODUCT)

ALL EXERIOR STEEL IN PROJECT IS TO BE GALVANIZED UNLESS PRIMED AND PAINTED IS APPROVED BY THE OWNER.

DIV 05

ALL WOOD IN PROJECT IS TO BE FSC CERTIFIED. ALL COMPOSITE WOOD PRODUCTS ARE TO CONTAIN NO UREA FORMALDEHYDE.

DECKING

1X6 IPE, ADVANTAGE LUMBER OR SIMILAR. PROVIDE A 2 YEAR SUPPLY OF A A LOW-VOC SEALER RECOMMENDED BY IPE MANUFACTURER TO THE OWNER.

SIDING

1X6 IPE SHIPLAP SIDING WITH RAINSCREEN SYSTEM - BASIS OF DESIGN "VANISH RAINSCREEN" BY IRONWOODS.
PROVIDE SAMPLE TO FOR OWNER'S APPROVAL

ROUGH CARPENTRY & SOLID STRUCTURAL LUMBER SEE PLANS

FINISH CARPENTRY

SOLID RED OAK $2\frac{1}{4}$ " WIDE WOOD FLOORING, FSC CERTIFIED, RIFT & QUARTER SAWN, SELECT OR BETTER, ALLEGHANY HARDWOOD OR SIMILAR, FINISHED IN FIELD TO MATCH EXISTING WOOD FLOOR. PROVIDE FINISH SAMPLE FOR OWNER'S APPROVAL.

DIV 07

INSULATION

INTERIOR - MINERAL WOOL SOUND ATTENUATION INSULATION EXTERIOR - ECOTOUCH PINK FIBERGLASS R-14 PLUS EXTRUDED POLYSTYRENE R5 PER INCH

ROOF ASSEMBLY

CONTRACTOR IS RESPONSIBLE FOR COMPATIBILITY OF SELECTED FLASHING, ROOFING, AND WATERPROOF AIR BARRIER TO FORM A COMPLETE WATERTIGHT BUILDING ENVELOPE. PROVIDE A COPY OF PRODUCT DATA TO OWNER. PROVIDE A 20 YEAR WARRANTY FOR ROOFING AND GREEN ROOF. ROOFING MANUFACTURER TO VISIT SITE AND PROVIDE A LETTER CERTIFYING QUALITY CRAFTSMANSHIP AND COMPATIBILITY OF MATERIALS.

EPDM ROOFING - NOTED UNDER GREEN ROOF ABOVE.

ROOF FLASHING - PROVIDE EPDM COMPATIBLE WITH MEMBRANE.

SEALANT

DIV 08

SLIDING DOOR

WESTERN WINDOWS SERIES 7650 SLIDING GLASS DOOR WITH INSULATED GLAZING, LOW-E COATING AND A THERMALLY BROKEN

FRAME.

WINDOWS & SKYLIGHTS

PELLA, ANDERSON, MARVIN, WESTERN WINDOWS, THERMALLY BROKEN FRAME WITH INSULATED GLASS UNIT, CLEAR GLASS AND LOW-E COATING WITH 0.40 SHGC OR BETTER FOR WINDOWS AND A SKYLIGHT U-FACTOR OF 0.55 OR BETTER. SUBMIT COLOR SAMPLES TO OWNER & AOR. PROVIDE SINGLE SOURCE MANUFACTURER FORALL DIV 8 MATERIALS. SUBMISSION OF PRODUCT DATA AND OWNER OR AOR APPROVAL IS REQUIRED FOR ALL DIV 8 MATERIALS PRIOR TO INSTALLATION. WINDOW U-FACTOR 0.32 OR BETTER PER IRC 402.1.2. OPERABLE WINDOWS TO HAVE LOCKING HARDWARE AND BE FITTED WITH SCREENS TYP.

DIV 09

NTERIOR PAINT

BENJAMIN MOORE AURA OR EQUAL LOW-VOC BRAND, COLOR TO MATCH EXISTING WALLS OR OWNER'S CHOICE.

PLUMBING:

PROVIDE NATURAL GAS CONVERSION KIT FOR FIRE TABLE AND GRILL AND INSTALL NATURAL GAS SERVICE TO THE ROOF TO SERVE BOTH. DESIGN ROUTING OF PIPE TO MINIMIZE IMPACT TO EXISTING CONSTRUCTION. PROVIDE PATCHING OF AREAS OPENED UP FOR GAS PIPE AND FINISH TO MATCH ADJACENT CONSTRUCTION. ADVISE OWNER ON PREFERRED GAS ROUTE AND IMPACT TO EXISTING CONSTRUCTION PRIOR TO SELECTIVE DEMOLITION. MINIMIZE IMPACT TO KITCHEN.

ELECTRICAL:

LIGHTING

CONTRACTOR TO PROVIDE ALL WIRING, ACCESSORIES AND SERVICE TO ENSURE A COMPLETE AND FUNCTIONAL ELECTRICAL INSTALLATION. ALL ELECTRICAL WORK TO BE BY A LICENSED ELECTRICIAN. SWITCHES ARE OWNER'S CHOICE.

PROVIDE GFCI AND EXTERIOR GRADE RECEPTACLES WITH ENCLOSED COVER PLATE FOR ELECTRICAL SERVICE ON ROOF.

DOWNLIGHTS:

LED:

SCONCE MAY BE OWNER PROVIDED. CONTRACTOR INSTALLED

FURNITURE

OWNER PROVIDED, CONTRACTOR INSTALLED.

4500 East West Highway #125 Bethesda, MD 20814 (240) 760-1037

ARCHITECTURE FOREVER

NOTE: Drawing may be printed at reduced scale

DRAFT - NOT FOR CONSTRUCTION

No. Date Revision

Key Plan

No. Date Revision

Revision

CLUSTER 26

Revision

N

Lincoln
PARK

EOR: JAMES GEORGE KONNICK PE AOR: CLAIR M. WHOLEAN AIA LEED AP BD+C

Project No. 2018-001

Date: 09/17/2018

Project:

ROOF REPLACEMENT WITH GREEN ROOF

Address: 16 10TH ST NE WASHINGTON DC 20002

Drawing Title:

ZONING NOTES & MATERIAL SPECIFICATIONS

Drawing No.:

T102.00

Sheets in Contract Set: 02 of 17

Sheets in DOB Set: 02 of 17

DEMOLITION NOTES

- 1. THIS PROJECT CONTAINS AN ACTIVE LEAK AROUND THE STAIR BULKHEAD WHICH MAY HAVE CAUSED DETERIORATION OF ARCHITECTURAL OR STRUCTURAL ELEMENTS NOT NOTED ON PLAN. IN THE CASE THAT ADDITIONAL DETERIORATED ELEMENTS ARE ENCOUNTERED, NOTIFY THE AOR FOR REMEDY. REPAIR OR REPLACEMENT OF ALL ELEMENTS DAMAGED BY LEAK IS INCLUDED IN THE SCOPE OF WORK.
- 2. PROVIDE TEMPORARY PROTECTION OF THE STAIR BULKHEAD, ROOF OPENINGS, AND ANY UNCOVERED ROOF AREAS THROUGHOUT THE DURATION OF CONSTRUCTION.
- 3. ROOF MOUNTED EQUIPMENT, CONDUIT, PIPE PENETRATIONS AND OTHER ROOF TOP ELEMENTS TO BE PROTECTED THROUGHOUT THE DURATION OF CONSTRUCTION.
- 4. DRAWINGS ARE BASED ON ARCHITECTURAL OBSERVATION OF EXISTING CONDITIONS. CONTRACTOR TO TAKE FIELD MEASUREMENTS AND VERIFY DIMENSIONS PRIOR TO FABRICATION AND INSTALLATION.
- 10. MATERIAL OF DEMOLTION SHALL BE DISPOSED OFF SITE. SALVAGE OR RECYCLE EXISTING MATERIALS WHEN REASONABLY POSSIBLE TO REDUCE CONSTRUCTION


EXISTING

WASTE IN GOOD FAITH.

- 11. SELECTIVE DEMOLITION IS TO BE DONE IN A WORKMANLIKE MANNER AND BE LIMITED TO THE AREAS INDICATED ON DRAWINGS. CREATE A CLEAR BOUNDARY BETWEEN REQUIRED SELECTIVE DEMOLITION AND ARCHITECTURAL ELEMENTS TO REMAIN AND BE PROTECTED. DAMAGE TO ANY PART OF THE BUILDING DUE TO SELECTIVE DEMOLITION IS THE CONTRACTOR'S RESPONSIBILITY TO REPAIR TO MATCH THE ORIGINAL CONDITION.
- 12. ALL SELECTIVE DEMOLITION AND REMOVALS IS TO BE PERFORMED IN ACCORDANCE WITH ALL APPLICABLE ENVIRONMENTAL AND SAFETY REGULATIONS ACCORDING TO FEDERAL, STATE AND LOCAL LAWS. COMPLIANCE IS THE CONTRACTOR'S RESPONSIBILITY.
- 13. PROVIDE DUST CONTROL MEASURES SO THAT CONSTRUCTION DUST DOES NOT ENTER THE LIVING AREA OR MECHANICAL SYSTEM.
- 14. AFTER DEMOLITION OF MATERIALS, THE RESULTING EXPOSED SURFACE SHALL MATCH AND BE SMOOTH, LEVEL AND FLUSH WITH EXISTING CONDITIONS.

EXISTING BATHROOM

±2'-8 1/2"

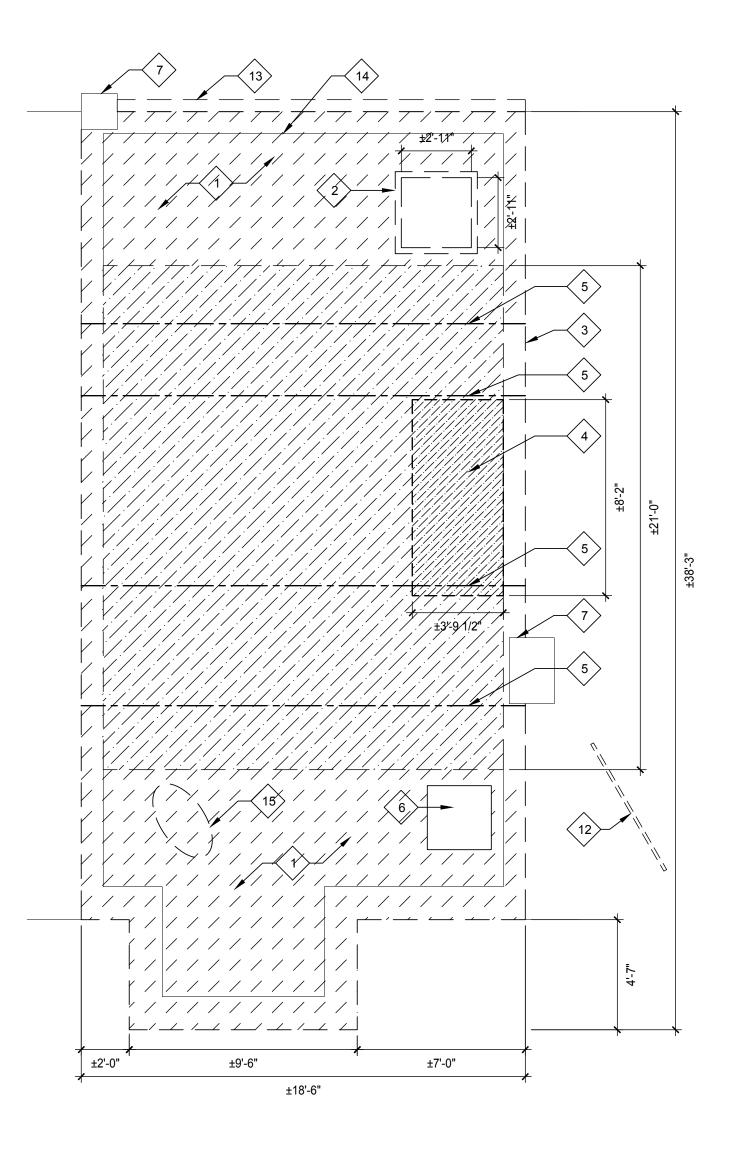

KEY NOTES

REMOVE EXISTING STANDING SEAM
METAL ROOF AND ACCESSORIES DOWN
TO SHEATHING. EVALUATE SHEATHING
FOR WATER DAMAGE AND ADVISE
OWNER/AOR ON SHEATHING TO BE
REPLACED DUE TO DETERIORATION.
NOTE STANDING SEAM ROOF
CONTINUES UNDER DECK



REMOVE EXISTING WOOD DECK AND HANDRAILS

REMOVE EXISTING STAIR BULKHEAD ENCLOSURE DOWN TO STRUCTURE

AND MASONRY PEDESTALS

EXISTING AC UNIT TO BE RELOCATED

AND PROTECTED DURING

REMOVE(4) EXISTING STEEL BEAMS

CONSTRUCTION

EXISTING CHIMNEY TO REMAIN AND BE

PROTECTED

REMOVE EXISTING WOOD STAIR
BETWEEN SECOND FLOOR AND ROOF

REMOVE EXISTING WAINSCOT
PARTITION AND EMBEDDED STAIR
STRINGER. NOTIFY AOR IF
STRUCTURE OR PIPING IS FOUND

INSIDE PARTITION

HANDRAIL.

REMOVE EXISTING WOOD HANDRAIL AND BALUSTERS. SALVAGE AND PROTECT FOR MATCHING REPLACEMENT HANDRAIL AND BALUSTERS. EXISTING BALUSTERS

MAY BE REINSTALLED WITH NEW

REMOVE ±25 SF GYPSUM BOARD WALL OR PLASTER WALL, ASSESS INTERIOR OF PARTITION FOR LEAK DAMAGE, REPAIR DEGRADED STUDS, CLEAN INTERIOR OF PARTITION AND REPLACE PARTITION TO MATCH EXISTING

REMOVE EXISTING ANTENNAE FROM ROOF OF ADJACENT HOUSE

EXISTING GUTTER TO BE SALVAGED AND REINSTALLED

EXISTING LOW PARAPET WALL TO REMAIN

15 REMOVE EXISTING SATTELITE

REMOVE EXISTING NEWEL POST TO
REMAIN AND BE PROTECTED. NOTE THIS
NEWEL POST IS TO BE MATCHED
EXACTLY IN SHAPE AND FINISH FOR THE
NEW CONSTRUCTION NEWEL POSTS

REMOVE EXISTING LIGHT FIXTURE




ARCHITECTURE FOREVE



4500 East West Highway #125 Bethesda, MD 20814 (240) 760-1037

NOTE: Drawing may be printed at reduced scale

DRAFT - NOT FOR CONSTRUCTION

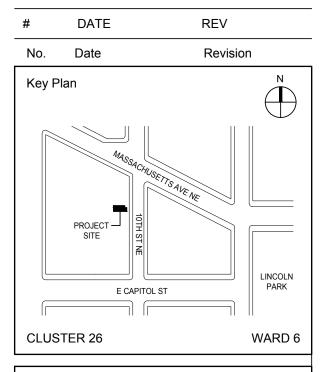

EOR: JAMES GEORGE KONNICK PE AOR: CLAIR M. WHOLEAN AIA LEED AP BD+C

Project No. 2018-001

Date: 09/17/2018

Project:

ROOF REPLACEMENT WITH GREEN ROOF

Address: 16 10TH ST NE WASHINGTON DC 20002

Drawing Title:

DEMOLITION PLANS

Drawing No.:

D101.00

Sheets in Contract Set: 03 of 17

t: Sheets in DOB Set: 03 of 17

SECOND FLOOR DEMOLITION PLAN

BEDROOM (NIC)

1 ROOF DEMOLITION PLAN



PHOTO A NO ROOFTOP ELEMENTS ARE VISIBLE.



PHOTO B

1. SATELLITE IS VISIBLE AND WILL BE PERMANENTLY REMOVED AS PART OF THIS PROJECT.



PHOTO C

- 1. SATELLITE IS VISIBLE AND WILL BE PERMANENTLY REMOVED AS PART OF THIS PROJECT.
- 2. AIR CONDITIONER IS VISIBLE AND WILL BE RELOCATED 2'-10" TO THE REAR.
- 2. EXISTING GUARDRAIL IS VISIBLE. THE LINE OF THE NEW GUARDRAIL IS 5'-7" FT BEHIND THE EXISTING GUARDRAIL. SEE PLAN ON A002.


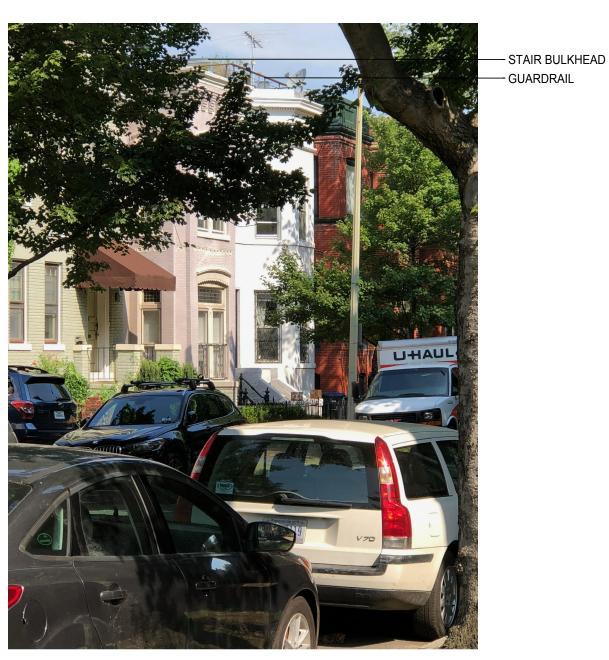


PHOTO D

- I. EXISTING STAIR BULKHEAD IS VISIBLE. THE NEW STAIR BULKHEAD WILL HAVE A SLOPING TOP REMOVING IT FROM THE VIEWSHED.
- 2. EXISTING GUARDRAIL IS VISIBLE. THE LINE OF THE NEW GUARDRAIL IS 5'-7" FT BEHIND THE EXISTING GUARDRAIL. SEE PLAN ON A002.
- 3. EXISTING SATTELITE IS ALSO VISIBLE AND WILL BE PERMANENTLY REMOVED.



1" = 72'-0"

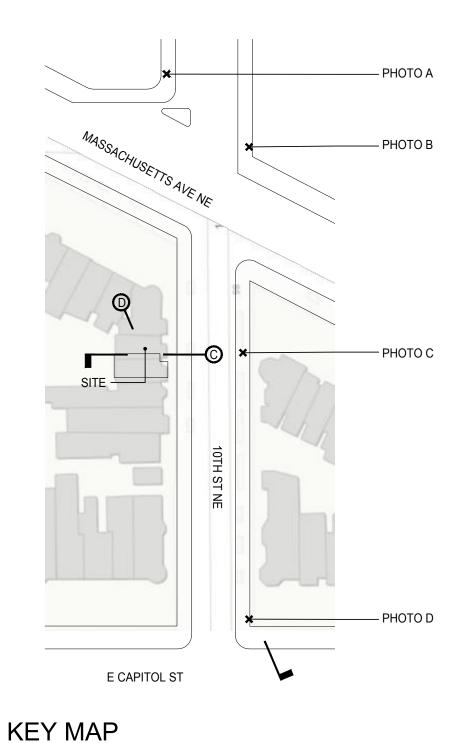


(S)(E)

4500 East West Highway #125 Bethesda, MD 20814 (240) 760-1037

NOTE: Drawing may be printed at reduced scale

DRAFT - NOT FOR CONSTRUCTION

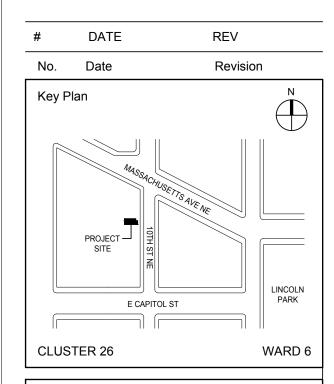

EOR: JAMES GEORGE KONNICK PE AOR: CLAIR M. WHOLEAN AIA LEED AP BD+C

Project No. 2018-001

09/17/2018

ROOF REPLACEMENT WITH GREEN ROOF

Address: 16 10TH ST NE WASHINGTON DC 20002

Drawing Title:


HISTORIC VIEWSHED COMPLIANCE

Drawing No.:

A001.00

Sheets in Contract Set: 04 of 17

Sheets in DOB Set: 04 of 17

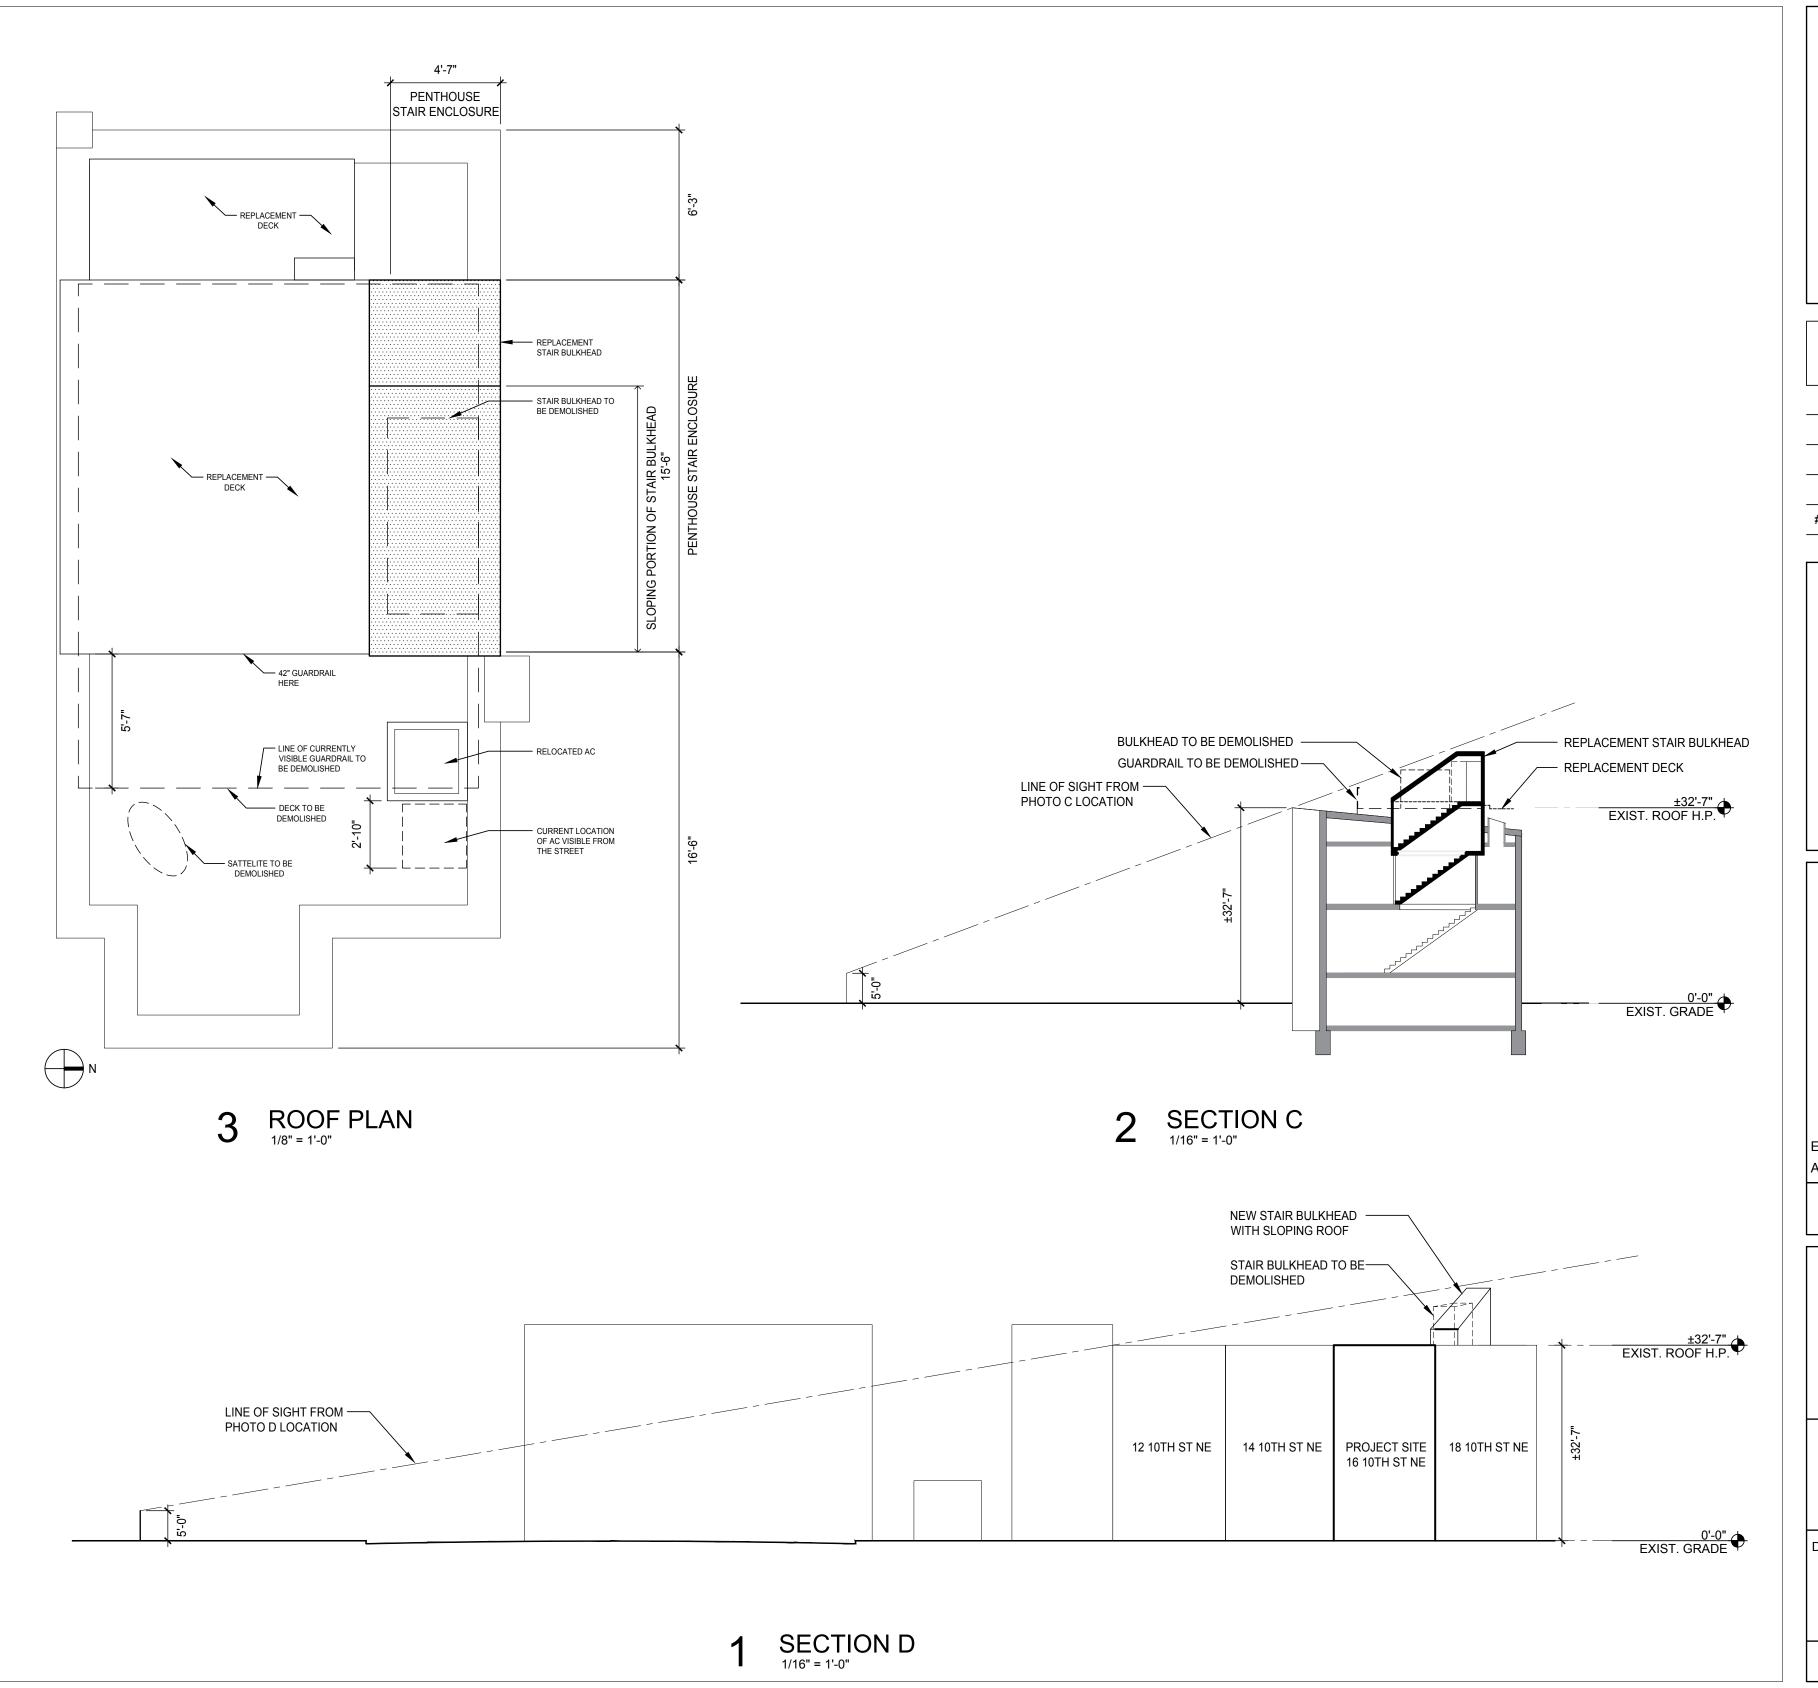





NOTE: Drawing may be printed at reduced scale

DRAFT - NOT FOR CONSTRUCTION

REV DATE No. Date Revision Key Plan PROJECT — LINCOLN PARK E CAPITOL ST CLUSTER 26 WARD 6

EOR: JAMES GEORGE KONNICK PE AOR: CLAIR M. WHOLEAN AIA LEED AP BD+C

Project No. 2018-001

09/17/2018

ROOF REPLACEMENT WITH GREEN ROOF

Address: 16 10TH ST NE WASHINGTON DC 20002

Drawing Title:

HISTORIC VIEWSHED COMPLIANCE


Drawing No.:

A002.00

Sheets in Contract Set: Sheets in DOB Set:

05 of 17

05 of 17

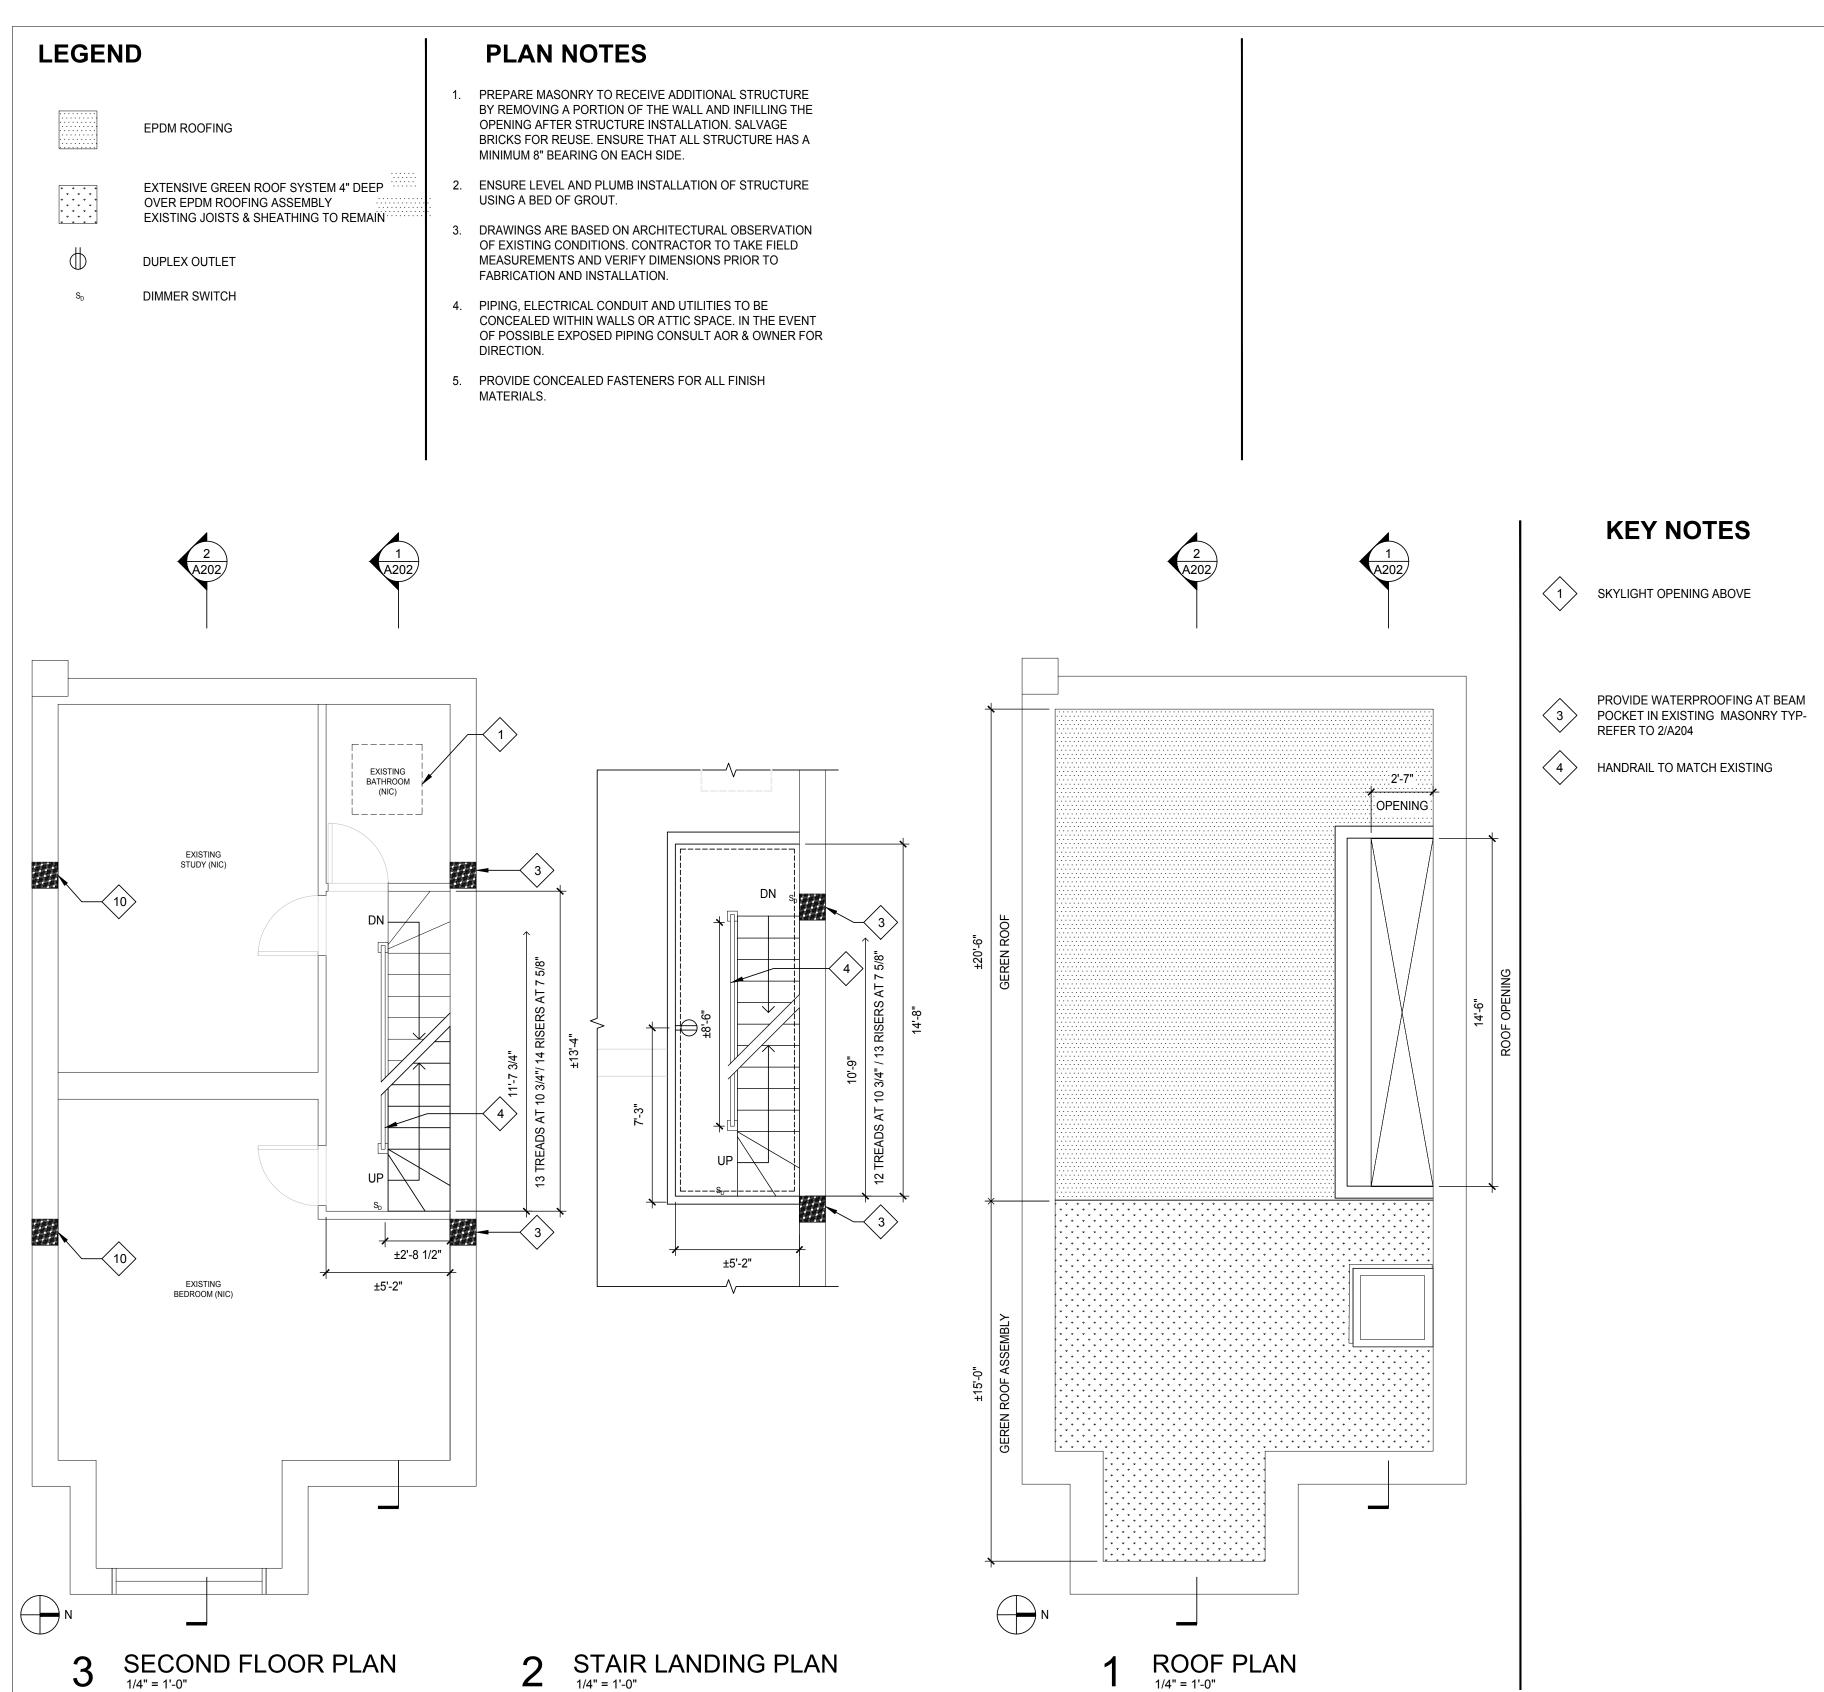






NOTE: Drawing may be printed at reduced scale

DRAFT - NOT FOR CONSTRUCTION

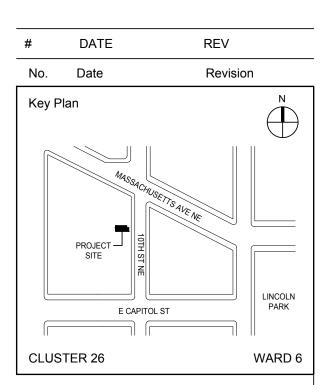

EOR: JAMES GEORGE KONNICK PE AOR: CLAIR M. WHOLEAN AIA LEED AP BD+C

Project No. 2018-001

09/17/2018

ROOF REPLACEMENT WITH GREEN ROOF

Address: 16 10TH ST NE WASHINGTON DC 20002

Drawing Title:

SECOND FL, STAIR **LANDING & ROOF PLANS**

Drawing No.:

A101.00

Sheets in Contract Set: 06 of 17

Sheets in DOB Set:

06 of 17

LEGEND PLAN NOTES

1X6 IPE DECKING FSC CERTIFIED ADVANTAGE LUMBER OR SIMILAR ALL FASTENERS EXTERIOR GRADE, SELECTED PER MANUFACTURER'S RECOMMENDATION AND CONCEALED

42" HIGH ATLANTIS LATITUDE SUN RAIL WITH FASCIA MOUNT BASE AND SOLID IPE 2"4" TOP RAIL ENCLOSING DECK ALL SIDES. NOTE TOP RAIL NOT SUPPLIED BY ATLANTIS. TOP RAIL TO MATCH IPE DECKING.

EXTENSIVE GREEN ROOF SYSTEM 4" DEEP OVER EPDM ROOFING ASSEMBLY **EXISTING JOISTS & SHEATHING TO REMAIN**


DUPLEX OUTLET EXTERIOR GRADE

FLOOR OUTLET EXTERIOR GRADE

DRAWINGS ARE BASED ON ARCHITECTURAL OBSERVATION OF EXISTING CONDITIONS. CONTRACTOR TO TAKE FIELD MEASUREMENTS AND VERIFY

DIMENSIONS PRIOR TO FABRICATION AND INSTALLATION.

11'-0 1/2" 2'-11" 5'-0 1/2" 11 BOARDS 2'-7" 10" 15'-7" AT 5 (15) $\langle 11 \rangle$ ĞAŢĔ 9 ±12'-10 1/2" ±18'-6"

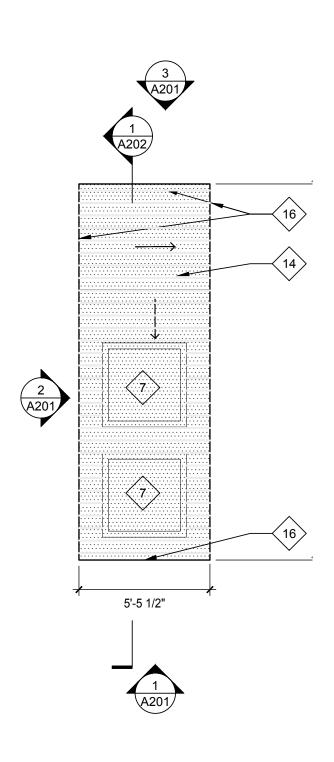

KEY NOTES

THRESHOLD FROM SLIDING DOOR MANUFACTURER

EXTEND EXISTING PLUMBING VENT STACK TO _

RELOCATE EXISTING AC UNIT AS INDICATED AND ENSURE THAT UNIT IS NOT VISIBLE FROM 10TH ST ALTERNATE

PROVIDE 1/2" AIR GAP AT EXISTING 4 BRICK CHIMNEY

HARDWOOD RED OAK FLOORING ON STAIR AND LANDING

REPLACEMENT SKYLIGHT TO MATCH EXISTING IN SIZE AND PROVIDE **UPGRADED ENERGY EFFICIENCY PER** T002. EXTEND ROOF FLASHING TO THE FULL HEIGHT OF THE CURB

3'-0" X 3'-0" SKYLIGHT

STAIR ENCLOSURE STUD WALL W/ IPE RAINSCREEN REFER TO DTL ON A201

 $\langle 9 \rangle$ RELOCATED EXISTING AC UNIT

GATE IN GAURDRAIL SYSTEM. CONSTRUCT TO MATCH GAURDRAIL SO GATE IS DISGUISED AND VISUALLY APPEARS AS A PART OF THE RAILING SYSTEM

EXISTING CHIMNEY TO REMAIN AND BE PROTECTED

OWNER PROCURED MARBLE SILL

13 SLIDING DOOR 5'-0" X 6'-8"

1/6 IPE SHIPLAP SIDING RAINSCREEN SLOPE 1/2" PER FOOT OVER 5/8"

PLYWOOD SHEATHING WITH CONTINUOUS WATERPROOF AIR BARRIER. PROVIDE R49 MIN INSULATION FOR ROOF OF ENCLOSURE

2" REVEAL BETWEEN DECK AND STAIR **ENCLOSURE**

2X4 ALL STUDS DOUBLE (2) 2X4 @ 16" O.C. WITH HORIZONTAL BRACING 48" O.C. AND DOUBLE HEADERS AROUND ALL OPENINGS

RELOCATE EXISTING HOSE BIB

(E)

4500 East West Highway #125 Bethesda, MD 20814 (240) 760-1037

NOTE: Drawing may be printed at reduced scale

DRAFT - NOT FOR CONSTRUCTION

REV DATE Revision No. Date Key Plan PROJECT — LINCOLN E CAPITOL ST CLUSTER 26 WARD 6

EOR: JAMES GEORGE KONNICK PE AOR: CLAIR M. WHOLEAN AIA LEED AP BD+C

Project No. 2018-001

09/17/2018

ROOF REPLACEMENT WITH GREEN ROOF

Address: 16 10TH ST NE WASHINGTON DC 20002

Drawing Title:

ROOF DECK PLAN & ROOF PLAN

Drawing No.:

A102.00

Sheets in Contract Set:


Sheets in DOB Set: 07 of 17 07 of 17

LEGEND

RECESSED ADJUSTABLE WALL WASH LED DOWNLIGHT

PLAN NOTES

DRAWINGS ARE BASED ON ARCHITECTURAL OBSERVATION OF EXISTING CONDITIONS. CONTRACTOR TO TAKE FIELD MEASUREMENTS AND VERIFY DIMENSIONS PRIOR TO FABRICATION AND INSTALLATION.

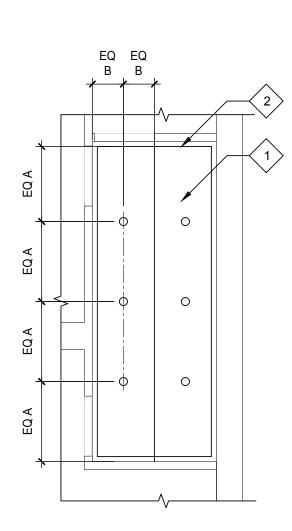

KEY NOTES



PTD GYPSUM BOARD BENJAMIN MOORE OC-17 DOVE WHITE TYP ALL CEILINGS



PROVIDE CROWN MOLDING TO MATCH FIRST FLOOR ON SECOND FLOOR AND MEZZANINE IN PROFILE, FINISH AND COLOR






4500 East West Highway #125 Bethesda, MD 20814 (240) 760-1037

NOTE: Drawing may be printed at reduced scale

DRAFT - NOT FOR CONSTRUCTION

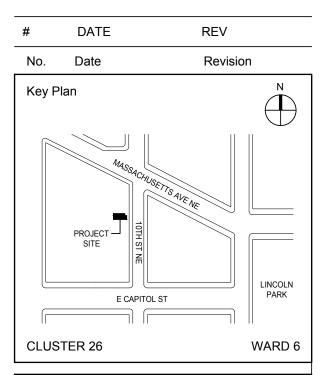

EOR: JAMES GEORGE KONNICK PE AOR: CLAIR M. WHOLEAN AIA LEED AP BD+C

Project No. 2018-001

09/17/2018

ROOF REPLACEMENT WITH GREEN ROOF

Address: 16 10TH ST NE WASHINGTON DC 20002

Drawing Title:


REFLECTED CEILING PLAN

Drawing No.:

A103.00

Sheets in Contract Set: 08 of 17

Sheets in DOB Set: 08 of 17

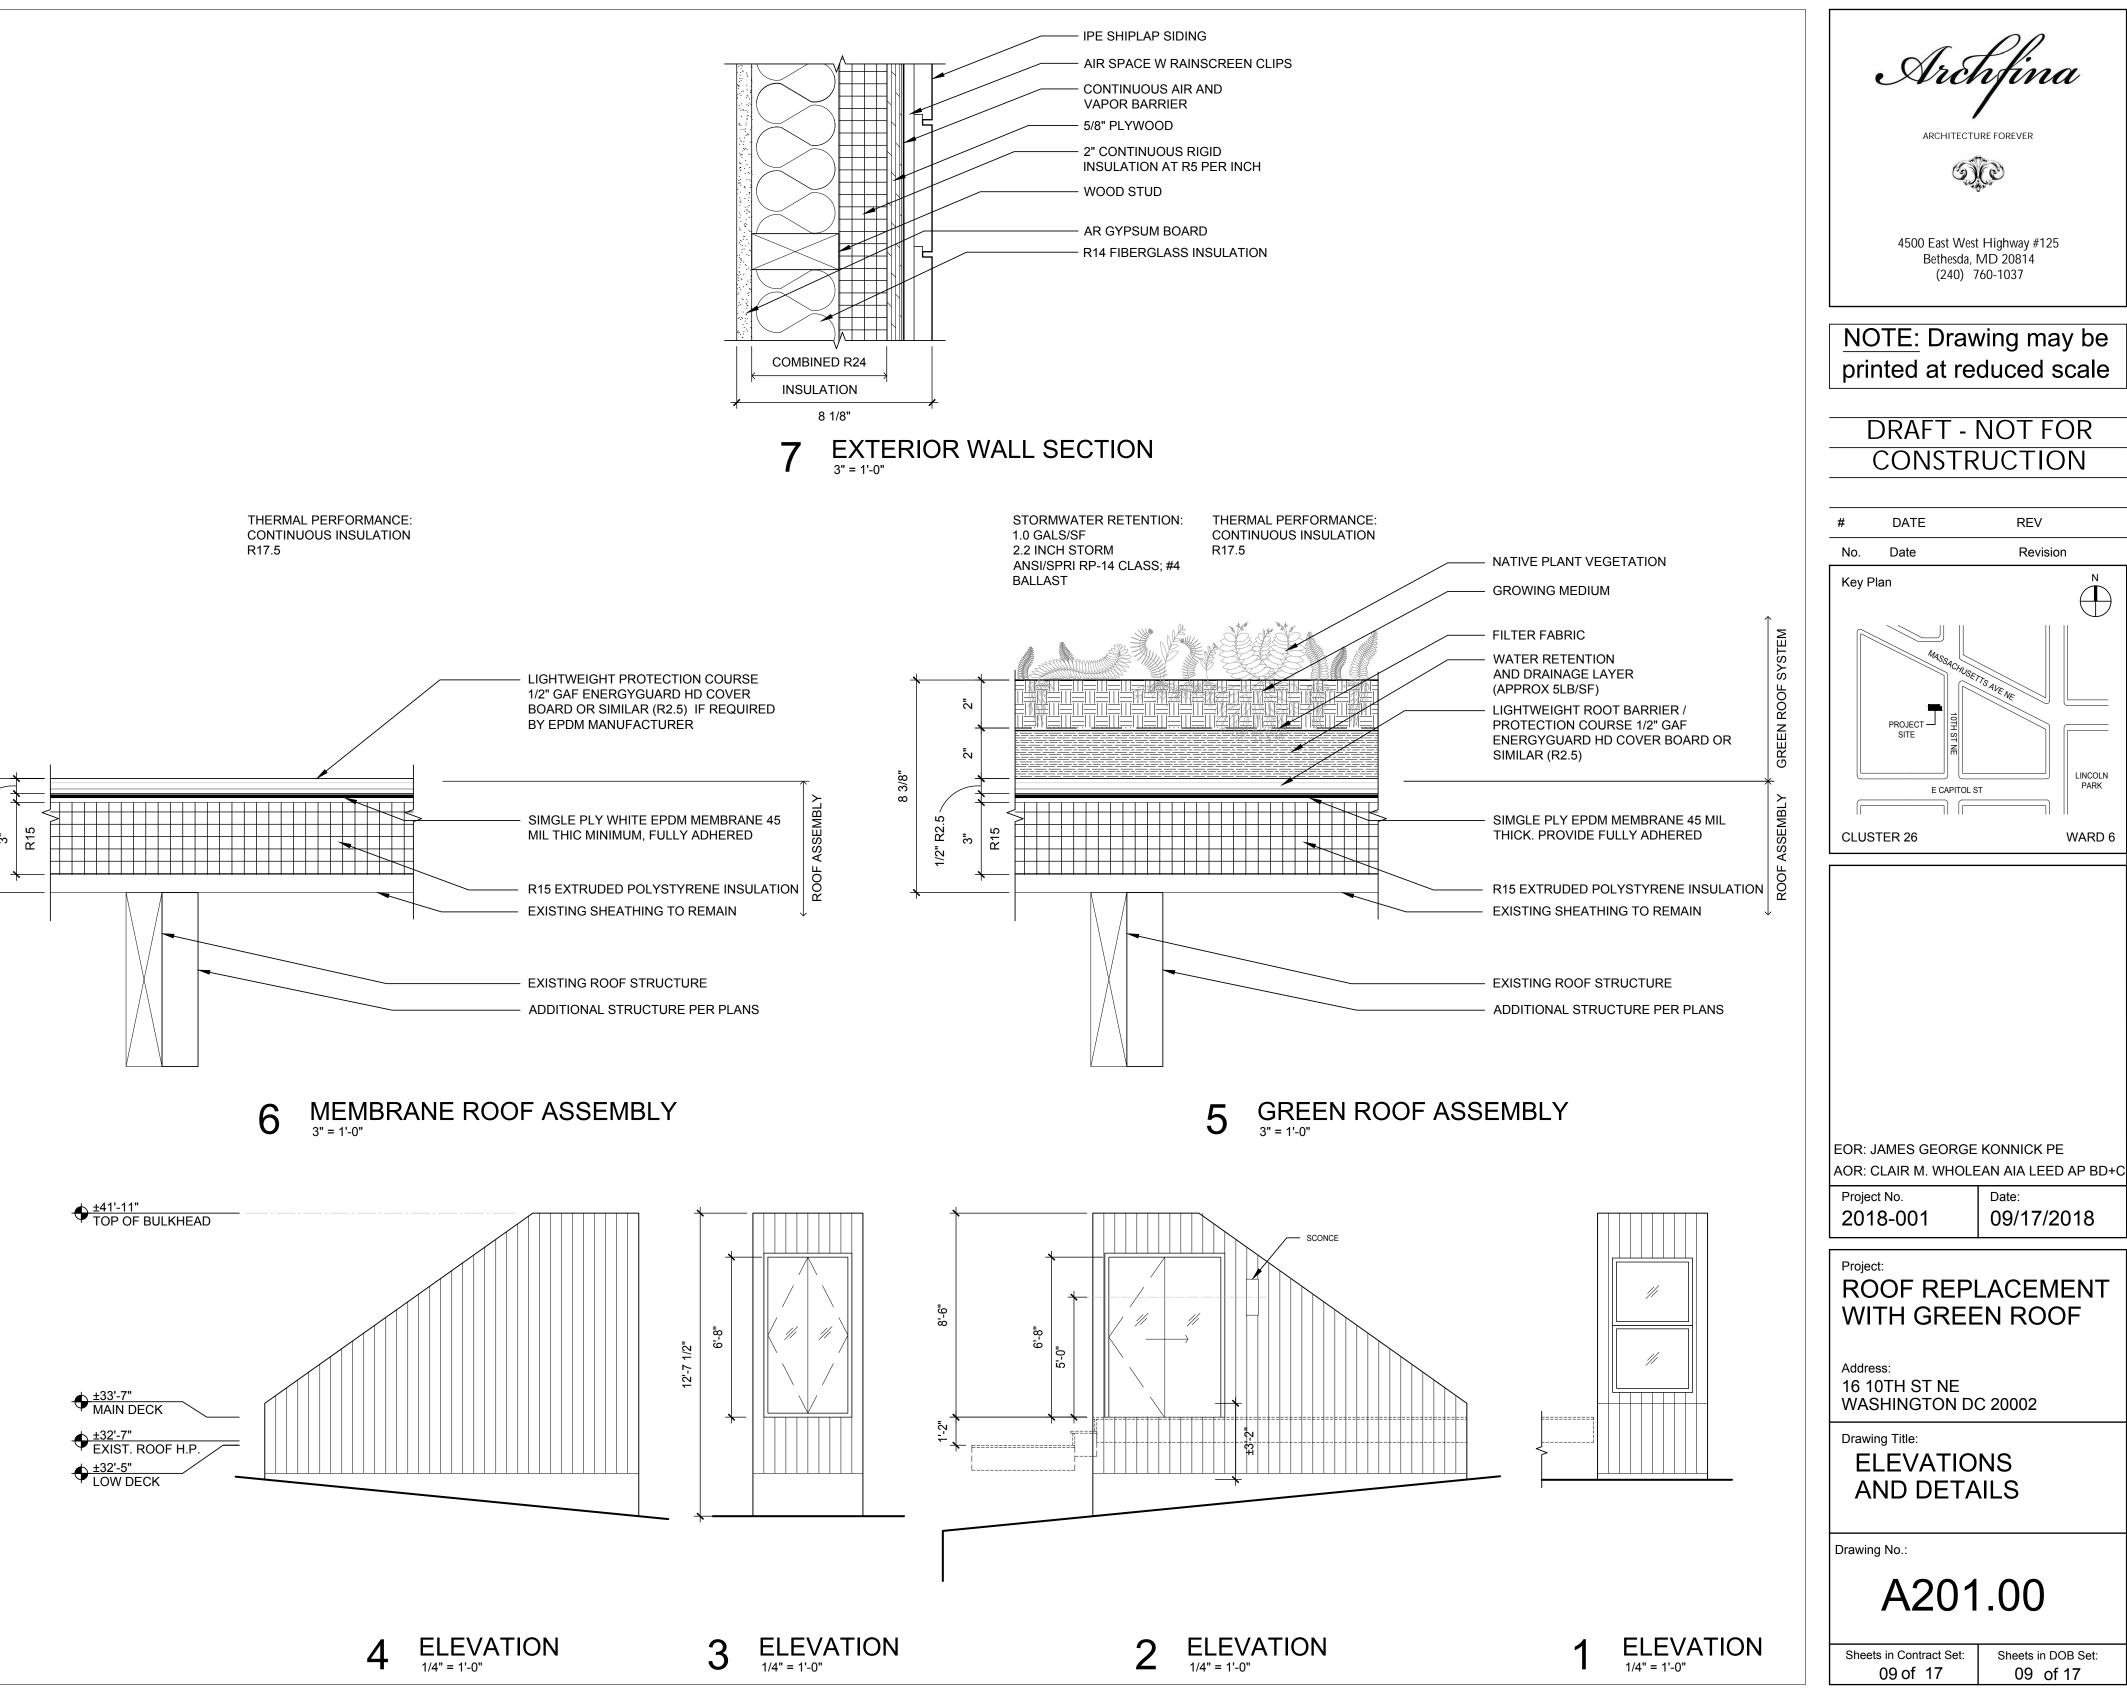






NOTE: Drawing may be printed at reduced scale

DRAFT - NOT FOR CONSTRUCTION

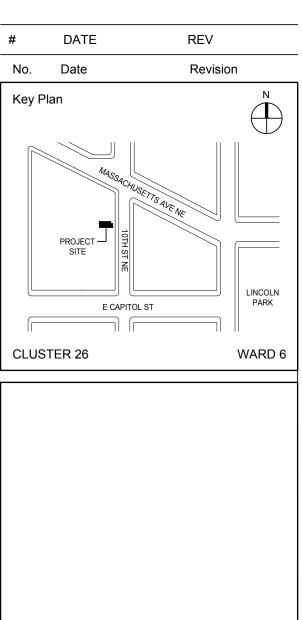

ROOF REPLACEMENT WITH GREEN ROOF

09/17/2018

Address: 16 10TH ST NE WASHINGTON DC 20002


Drawing Title:

ELEVATIONS AND DETAILS

Drawing No.:

A201.00

Sheets in Contract Set: Sheets in DOB Set: 09 of 17 09 of 17

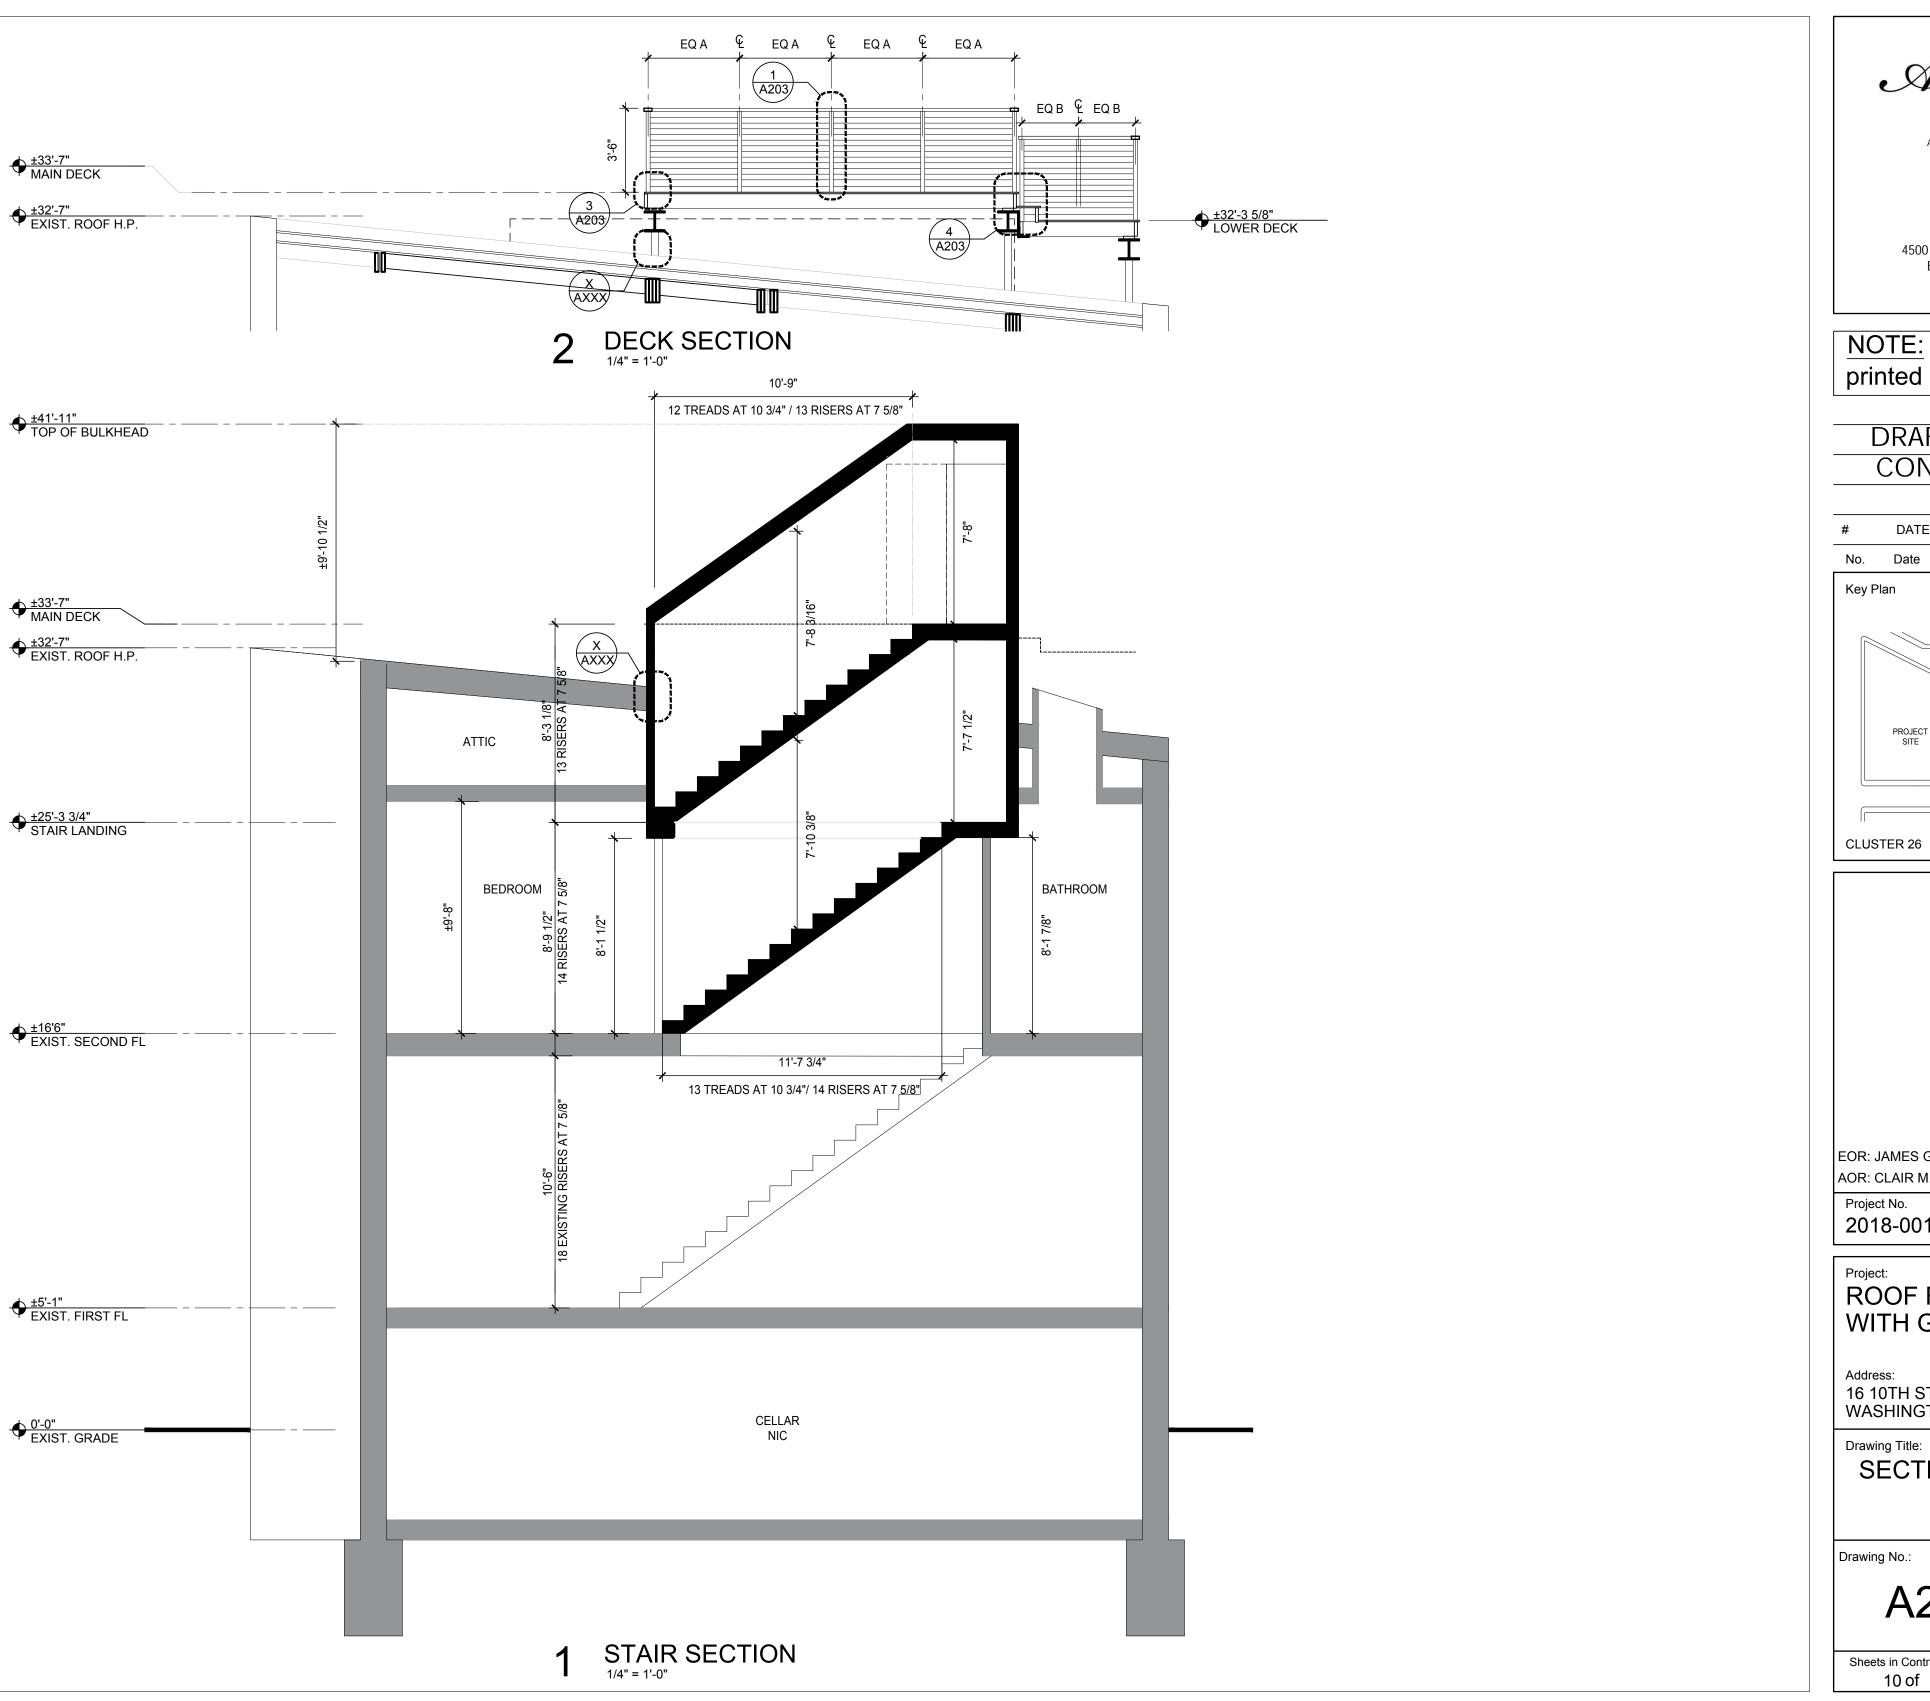



NOTE: Drawing may be printed at reduced scale

DRAFT - NOT FOR CONSTRUCTION

#	DATE	REV
No.	Date	Revision
Key P	lan	$\bigcap_{i=1}^{N}$
	MASSACHU	ISETTS AVE NE
	PROJECT 101H ST	
	E CAPITO	LINCOLN PARK
CLUS	WARD 6	

EOR: JAMES GEORGE KONNICK PE AOR: CLAIR M. WHOLEAN AIA LEED AP BD+C

2018-001

09/17/2018

ROOF REPLACEMENT WITH GREEN ROOF


Address: 16 10TH ST NE WASHINGTON DC 20002

SECTIONS

A202.00


Sheets in Contract Set: 10 of 17


Sheets in DOB Set: 10 of 17

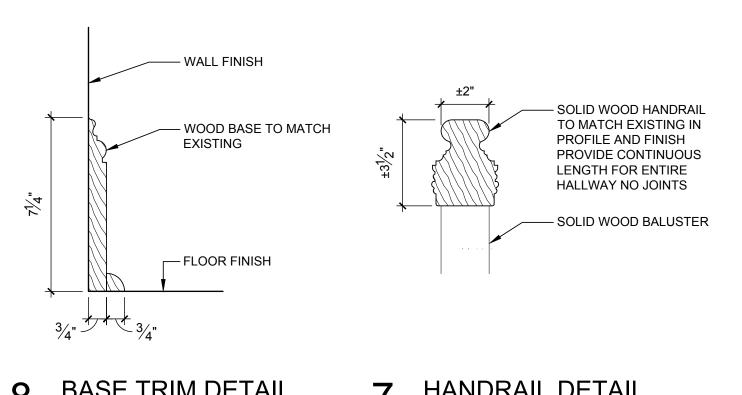


BASE TRIM DETAIL 1" = 1'-0"

HANDRAIL DETAIL 1" = 1'-0"

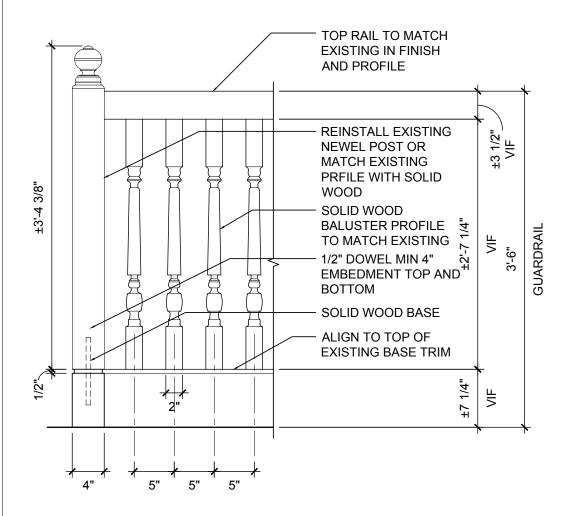

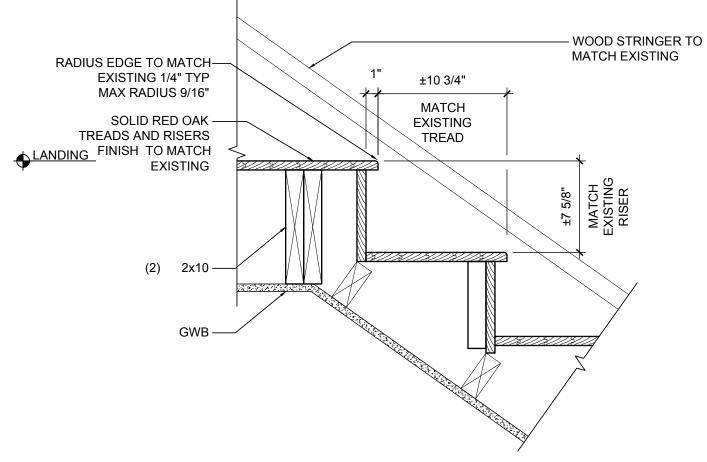

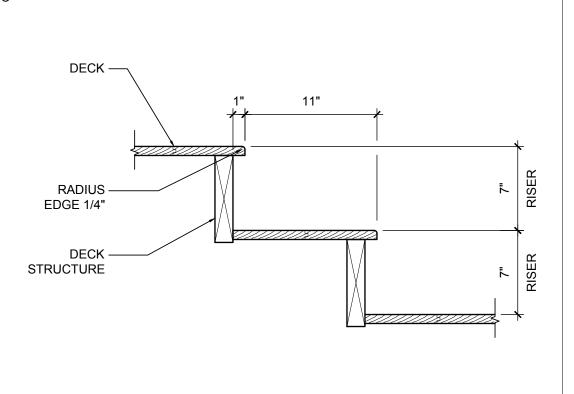

INTERIOR GUARDRAIL
1" = 1'-0" 6

GUARDRAIL

ASSEMBLY

STRUCTURE

ATTACHMENT BY GUARDRAIL


MANUFACTURER

DECK

FASICIA-


INTERIOR STAIR DETAIL

1" = 1'-0"

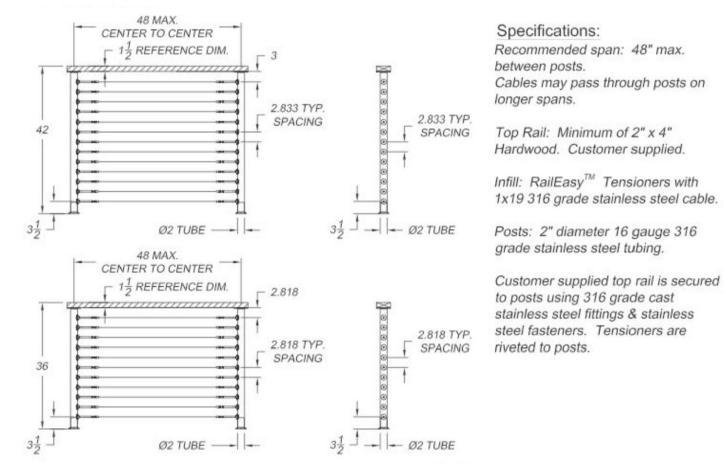

DECK STAIR DETAIL

1" = 1'-0"

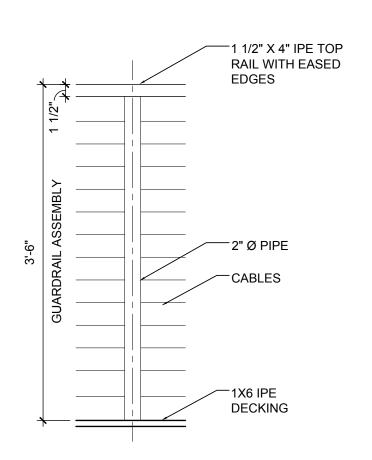

3 POST ATTACHMENT DETAIL

GUARDRAIL DETAIL

GUARDRAIL DETAIL


1" = 1'-0"

(D)

NOTE: Drawing may be printed at reduced scale

4500 East West Highway #125 Bethesda, MD 20814 (240) 760-1037

DRAFT - NOT FOR CONSTRUCTION

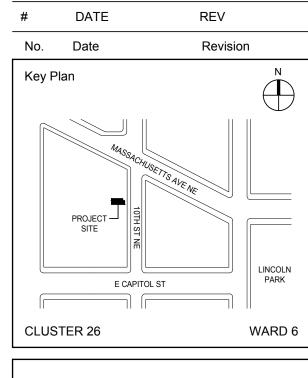

EOR: JAMES GEORGE KONNICK PE AOR: CLAIR M. WHOLEAN AIA LEED AP BD+C

Project No. 2018-001

09/17/2018

Project: **ROOF REPLACEMENT** WITH GREEN ROOF

Address: 16 10TH ST NE WASHINGTON DC 20002

Drawing Title: **DETAILS**

Drawing No.:

A203.00

Sheets in Contract Set: 11 of 17

Sheets in DOB Set: 11 of 17

STRUCTURAL NOTES

- 1. PREPARE MASONRY TO RECEIVE ADDITIONAL STRUCTURE BY REMOVING A PORTION OF THE WALL AND INFILLING THE OPENING AFTER STRUCTURE INSTALLATION. SALVAGE BRICKS FOR REUSE. ENSURE THAT ALL STRUCTURE HAS A MINIMUM 8" BEARING ON EACH SIDE.
- 2. ENSURE LEVEL AND PLUMB INSTALLATION OF STRUCTURE USING A BED OF GROUT.
- 3. DRAWINGS ARE BASED ON ARCHITECTURAL OBSERVATION OF EXISTING CONDITIONS. CONTRACTOR TO TAKE FIELD MEASUREMENTS AND VERIFY DIMENSIONS PRIOR TO FABRICATION AND INSTALLATION.
- 4. STRUCTURAL DRAWINGS ARE TO BE USED IN CONJUNCTION WITH THE REST OF THE CONTRACT DOCUMENTS.
- 5. THE GENERAL CONTRACTOR SHALL ENSURE THAT ALL CONSTRUCTION METHODS USED WILL NOT CAUSE DAMAGE TO ADJACENT BUILDINGS, UTILITIES, OR OTHER PROPERTY.
- 6. THE GENERAL CONTRACTOR SHALL OBTAIN COPIES OF THE LATEST CONTRACT DOCUMENTS, INCLUDING ALL ADDENDA, AND PROVIDE THE RELEVANT PORTIONS TO ALL SUB-CONTRACTORS AND SUPPLIERS PRIOR TO OF SUBMITTAL OF SHOP DRAWINGS AND FABRICATION AND ERECTION
- 7. THE CONTRACTOR SHALL COMPARE AND COORDINATE THE DRAWINGS OF ALL DISCIPLINES AND REPORT ANY DISCREPANCIES BETWEEN THE DRAWINGS TO THE ARCHITECT AND ENGINEER.
- 8. TYPICAL DETAILS APPLY TO ALL SAME OR SIMILAR SITUATIONS EVEN WHEN NOT KEYED AT EACH LOCATION.
- 9. THE CONTRACTOR SHALL REVIEW AND DETERMINE THAT DIMENSIONS ARE COORDINATED BETWEEN ARCHITECTURAL AND STRUCTURAL DRAWINGS PRIOR TO FABRICATION AND START OF CONSTRUCTION.
- 10. NO STRUCTURAL MEMEBER SHALL BE CUT OR OTHERWISE REDUCED IN STRENGTH UNLESS APPROVED BY THE EOR.
- THE GENERAL CONTRACTOR SHALL BE RESPONSIBLE FOR VERIFYING AND COORDINATING DIMENSIONS, ELEVATIONS, AND THE WORK OF ALL TRADES.
- 12. THE CONTRACTOR SHALL SHORE AND PROTECT EXISTING CONSTRUCTION UNTIL NEW PERMANENT WORK IS IN PLACE.
- 13. THE CONTRACTOR SHALL BE RESPONSIBLE FOR COMPLYING WITH ALL APPLICABLE CODES AND ORDINANCES.
- 14. WHERE CONFLICTS EXIST BETWEEN STRUCTURAL DOCUMENTS THE STRICTEST REQUIREMENTS, AS INDICATED BY THE STRUCTURAL ENGINEER SHALL GOVERN.
- 15. THE CONTRACT DRAWINGS REPRESENT THE COMPLETED STRUCTURE AND ARE NOT INTENDED TO INDICATE THE MEANS OR METHODS OF CONSTRUCTION. THE CONTRACTOR SHALL SUPERVISE AND DIRECT THE WORK AND SHALL BE SOLELY RESPONSIBLE FOR CONSTRUCTION MEANS, METHODS, PROCEDURES, TECHNIQUES, SEQUENCES, AND FOR JOB SAFETY.
- 16. THE AOR/EOR DOES NOT HAVE CONTROL OR CHARGE OF, AND SHALL NOT BE RESPONSIBLE FOR, CONSTRUCTION MEANS, METHODS, TECHNIQUES, SEQUENCES, PROCEDURES, SAFETY PRECAUTIONS AND PROGRAMS IN CONNECTION WITH THE WORK, OR FOR THE FAILURE OF ANY OF THEM TO CARRY OUT THE WORK IN ACCORDANCE WITH THE CONTRACT DOCUMENTS.
- 17. PERIODIC SITE OBSERVATION VISITS MAY BE PROVIDED BY THE STRUCTURAL ENGINEER. THE SOLE PURPOSE OF THESE OBSERVATIONS IS TO REVIEW THE GENERAL CONFORMANCE OF THE CONSTRUCTION WITH THE STRUCTURAL CONTRACT DOCUMENTS. THESE LIMITED OBSERVATIONS SHOULD NOT BE CONSTRUED AS CONTINUOUS OR EXHAUSTIVE TO VERIFY THAT ALL CONSTRUCTION IS IN COMPLIANCE WITH THE CONSTRUCTION DOCUMENTS. THE GENERAL CONTRACTOR SHALL BE RESPONSIBLE FOR PERFORMING ALL WORK IN COMPLIANCE WITH THE CONSTRUCTION DOCUMENTS.
- 18. TEMPORARY BRACING OF STRUCTURAL STEEL ELEMENTS IS THE RESPONSIBILITY OF THE CONTRACTOR. STRUCTURAL STABILITY SHALL BE MAINTAINED AT ALL TIMES DURING THE ERECTION PROCESS.
- 19. CONTRACTOR MUST PROVIDE NOTIFICATION TO THE ERECTOR THAT THE SUPPORTING WALLS HAVE SUFFICIENT STRENGTH TO SUPPORT THE STEEL TO BE ERECTED BEFORE ERECTING STRUCTURAL STEEL.
- 20. NO FIELD WELDING OF HOT DIPPED GALVANIZED MEMBERS IS
- 21. ALL EXTERIOR ELEMENTS AND THOSE ELEMENTS NOTED TO BE GALVANIZED SHALL BE HOT DIPPED GALVANIZED IN ACCORDANCE WITH ASTM A123 AFTER SANDBLAST CLEANING PER SSPC-SP10. USE ASTM A325 BOLTS HOT DIPPED GALVANIZED WITH GALVANIZED HARDENED WASHERS AND GALVANIZED HEAVY HEX NUTS FOR BOLTING OF GALVANIZED ITEMS.

22. MEMBERS NOTED AS "CONTINUOUS" SHALL BE FULLY WELDED AT ALL BUTT SPLICES OR CONNECTIONS SHALL BE DETAILED TO PROVIDE CONTINUITY.

SPECIAL INSPECTIONS

STRUCTURAL STEEL

DESIGN LOADS

ROOF

DEAD LOAD - 20 PSF LIVE LOAD - 30 PSF (SNOW)

GREEN ROOF

DEAD LOAD - 35 PSF LIVE LOAD - 30 PSF (SNOW)

WIND LOAD

WIND SPEED 115 MPH, EXPOSURE B

MATERIAL NOTES

STRUCTURAL STEEL

ALL W BEAMS A992. ALL OTHER STEEL A36.

ALL STEEL EXPOSED TO THE ELEMENTS SHALL BE GALVANIZED. REFER TO ALTERNATES ON T001.

UMBER

ALL LUMBER EXCEPT STUDS SHALL BE YELLOW PINE NO. 1 PRESSURE TREATED

ALL STUDS SHALL BE SPRUCE, PINE, OR FIR, SURFACE DRY, CONSTRUCTION GRADE

<u>OLTS</u>

ALL EXPANSION ANCHORS TO BE HILTI AND TO BE GALVANIZED STEEL OR STAINLESS STEEL FOR EXTERIOR APPLICATION.

MECHANICAL ANCHORS INTO MASONRY OR GROUT FILLED CELLS, USE THE FOLLOWING (UNO):

- A. HILTI KWIK BOLT 3 MASONRY ANCHORS (ICC-ES ESR1385)B. SIMPSON STRONG-TIE WEDGE-ALL ANCHOR(WA)
- B. SIMPSON STRONG-TIE WEDGE-ALL ANCHOR(WA)
 (ICBO-ES ER-3631) (FL5415)

ADHESIVE ANCHORS INTO MASONRY OR GROUT FILLED CELLS, USE THE FOLLOWING (UNO):

- A. HILTI HIT HY-150 MAX ADHESIVE (ICC-ES ESR1967)
- B. SIMPSON STRONG-TIE SET EPOXY-TIE ADHESIVE (SET) (ICC-ES ESR1772)(FL5550)

<u>GROUT</u>

NON-SHRINK, NON-METALLIC GROUT WITH A 28 DAY STRENGTH OF 5000 PSI SHALL BE USED UNDER BASE PLATES AND SHALL CONFORM TO CORPS OF ENGINEERS CRD-C621, FACTORY PREMIX GROUT. SEE SPECIFICATIONS FOR TESTING REQUIREMENTS.

EXISTING CONDITIONS:

THE CONTRACTOR SHALL FIELD VERIFY ALL EXISTING CONDITIONS
DEPICTED ON THESE DRAWINGS AND NOTIFY ENGINEER AND ARCHITECT

WHERE EMBEDDING STRUCTURE INTO EXISTING MASONRY, CONTRACTOR SHALL VISUALLY INSPECT MASONRY AND ADVISE AOR/EOR IF THE MASONRY APPEARS NOT TO BE STRUCTURALLY SOUND IN ANY WAY. CONDITIONS SUCH AS WATER INFILTRATION, MOLD, LOOSE MORTAR, CRACKING OR CRUMBLING BRICKS, CRACKING OR DELAMINATED JOINTS AND HEAVY WEATHERING ARE TO BE REPORTED TO AOR/EOR FOR REPAIR PRIOR TO ANCHORING STRUCTURE. MASONRY REPAIRS REQUIRED FOR PROPER STRUCTURAL ANCHORING ARE INCLUDED IN THE SCOPE OF WORK.



4)(3)

4500 East West Highway #125 Bethesda, MD 20814 (240) 760-1037

NOTE: Drawing may be printed at reduced scale

DRAFT - NOT FOR CONSTRUCTION

DATE REV

No. Date Revision

Key Plan

PROJECT OF SITE STANS ALVE NICE SITE SITE STANS ALVE NICE SITE STANS ALVE NICE SITE STANS ALVE NICE SITE STANS ALVE NICE STANS ALVE N

EOR: JAMES GEORGE KONNICK PE AOR: CLAIR M. WHOLEAN AIA LEED AP BD+C

Project No. 2018-001

09/17/2018

Project:

ROOF REPLACEMENT WITH GREEN ROOF

Address:

16 10TH ST NE WASHINGTON DC 20002

Drawing Title:


STRUCTURAL NOTES LOADS AND SPECIAL INSPECTIONS


Drawing No.:

S001.00

Sheets in Contract Set: 13 of 17


Sheets in DOB Set: 13 of 17

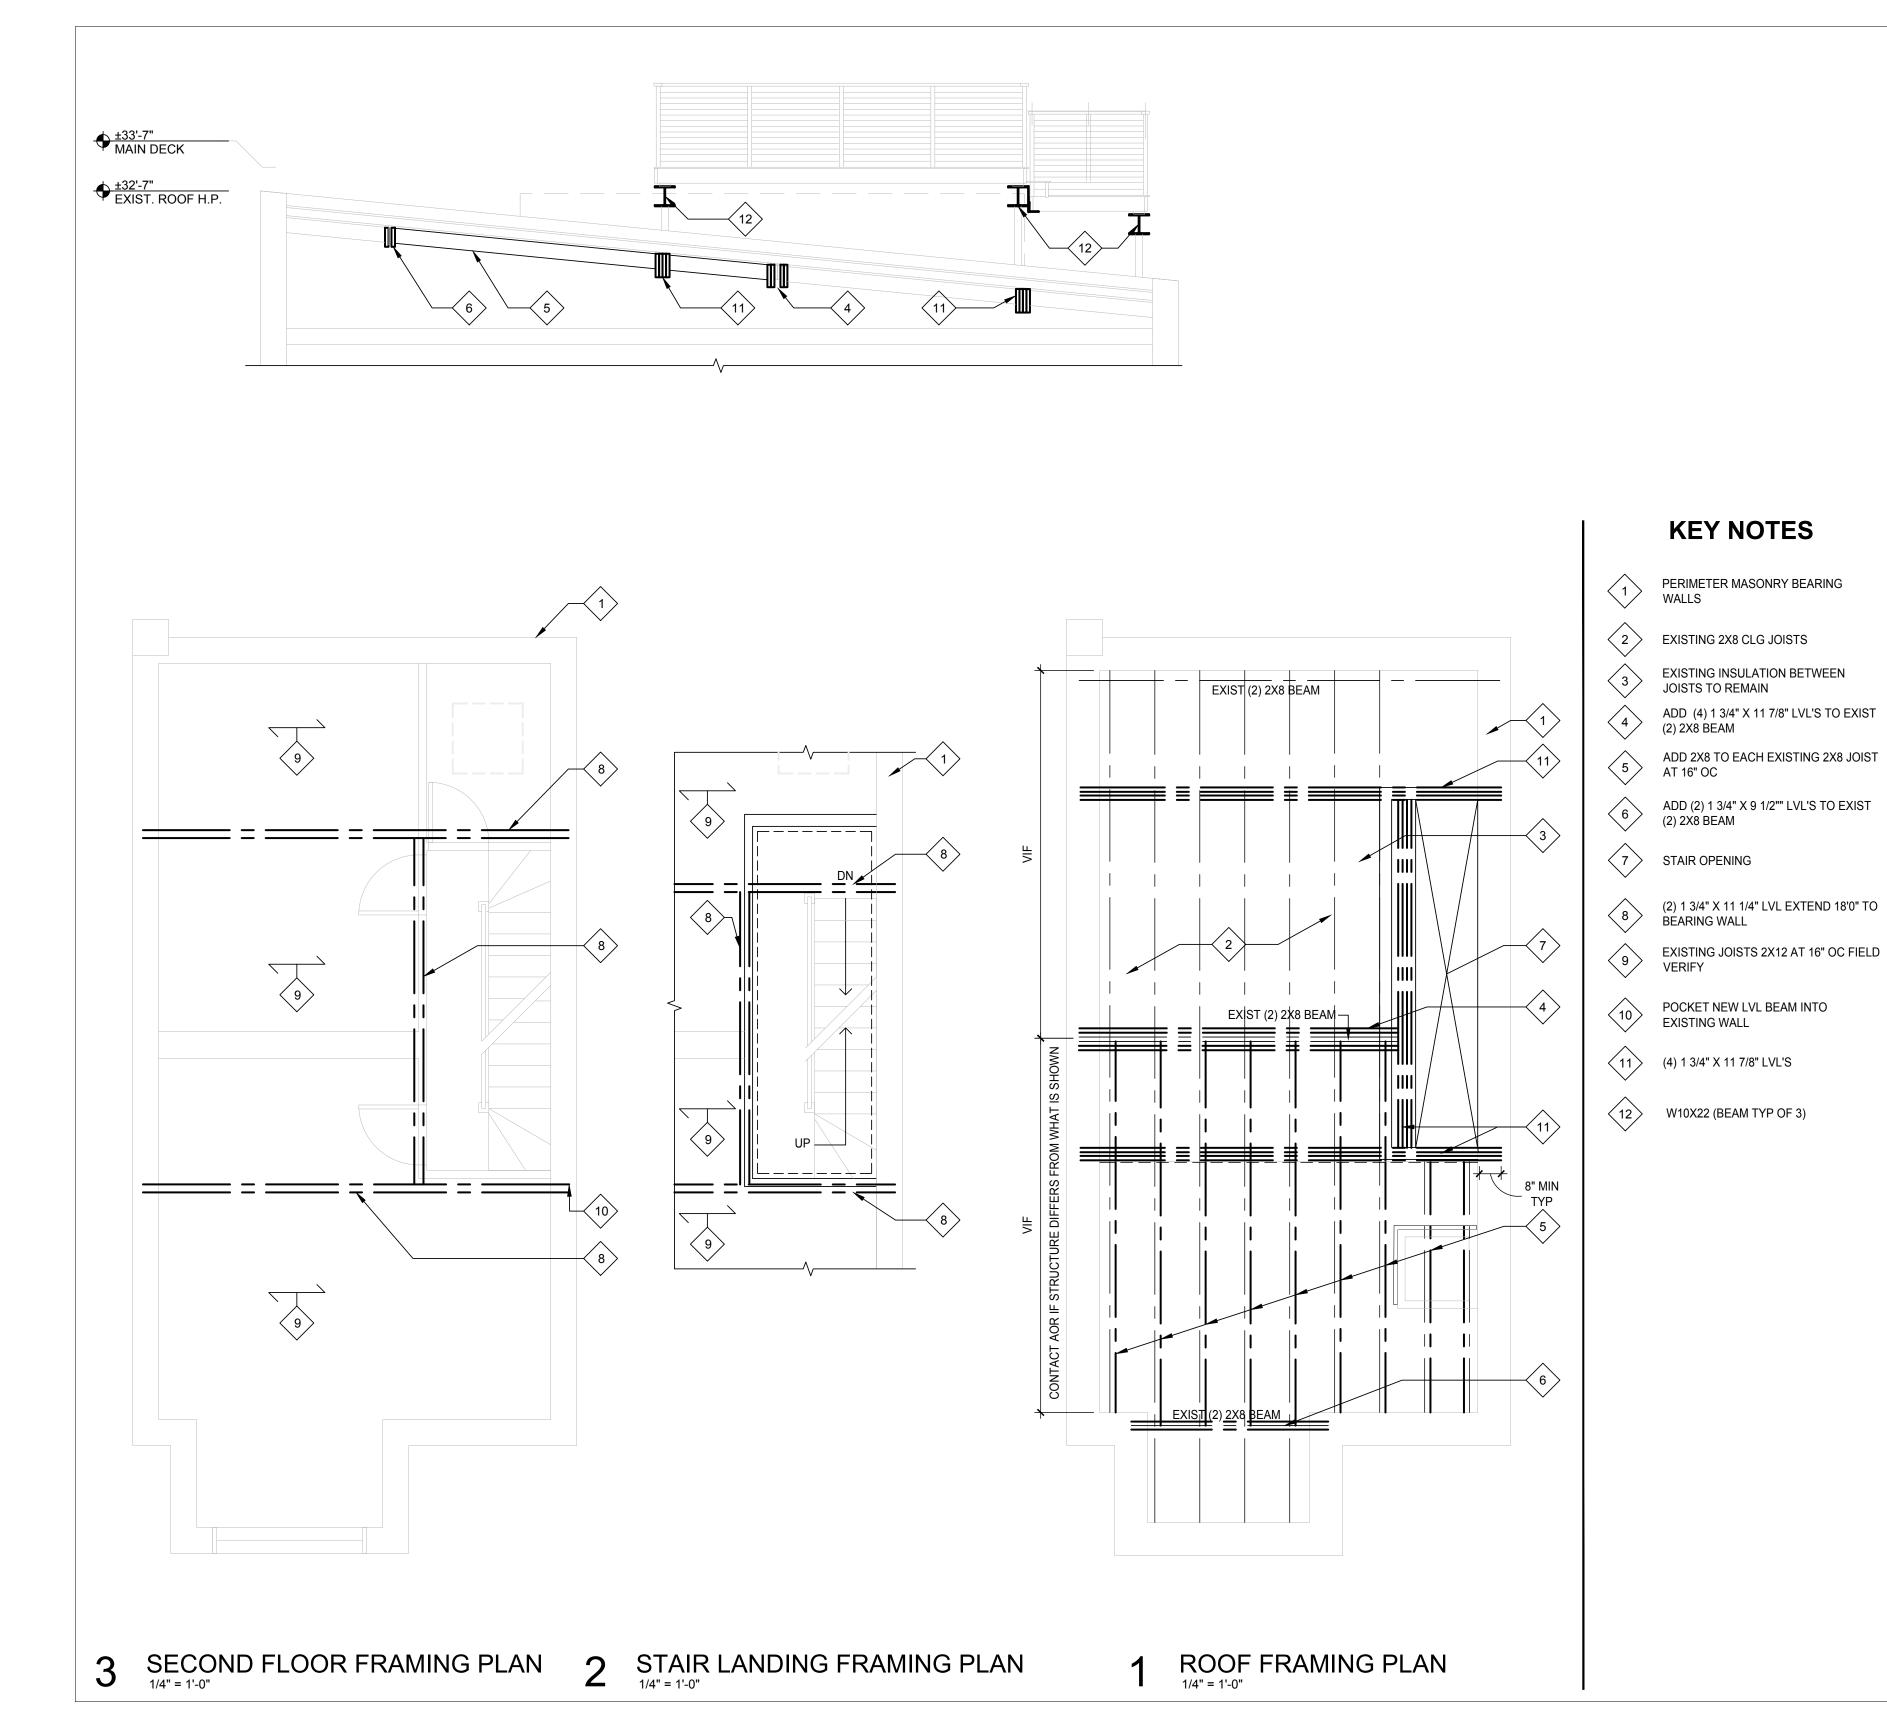

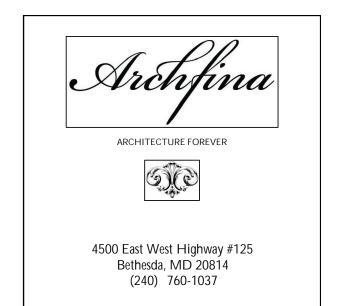

NOTE: Drawing may be printed at reduced scale

DRAFT - NOT FOR CONSTRUCTION

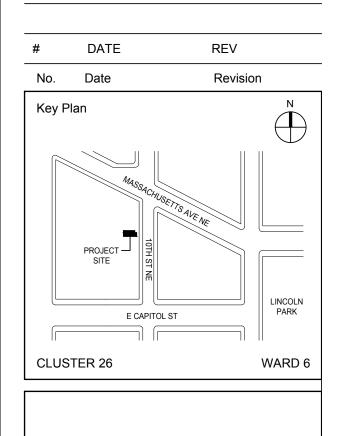

EOR: JAMES GEORGE KONNICK PE

AOR: CLAIR M. WHOLEAN AIA LEED AP BD+C

Project No. 2018-001

09/17/2018

Project:

ROOF REPLACEMENT WITH GREEN ROOF

Address: 16 10TH ST NE WASHINGTON DC 20002

Drawing Title:

SECOND FL, STAIR LANDING & ROOF FRAMING PLANS

Drawing No.:

S101.00


Sheets in DOB Set:


15 of 17

Sheets in Contract Set: 15 of 17

STRUCTURAL NOTES

- 1. PREPARE MASONRY TO RECEIVE ADDITIONAL STRUCTURE BY REMOVING A PORTION OF THE WALL AND INFILLING THE OPENING AFTER STRUCTURE INSTALLATION. SALVAGE BRICKS FOR REUSE. ENSURE THAT ALL STRUCTURE HAS A MINIMUM 8" BEARING ON EACH SIDE.
- 2. ENSURE LEVEL AND PLUMB INSTALLATION OF STRUCTURE USING A BED OF GROUT.
- 3. DRAWINGS ARE BASED ON ARCHITECTURAL OBSERVATION OF EXISTING CONDITIONS. CONTRACTOR TO TAKE FIELD MEASUREMENTS AND VERIFY DIMENSIONS PRIOR TO FABRICATION AND INSTALLATION.

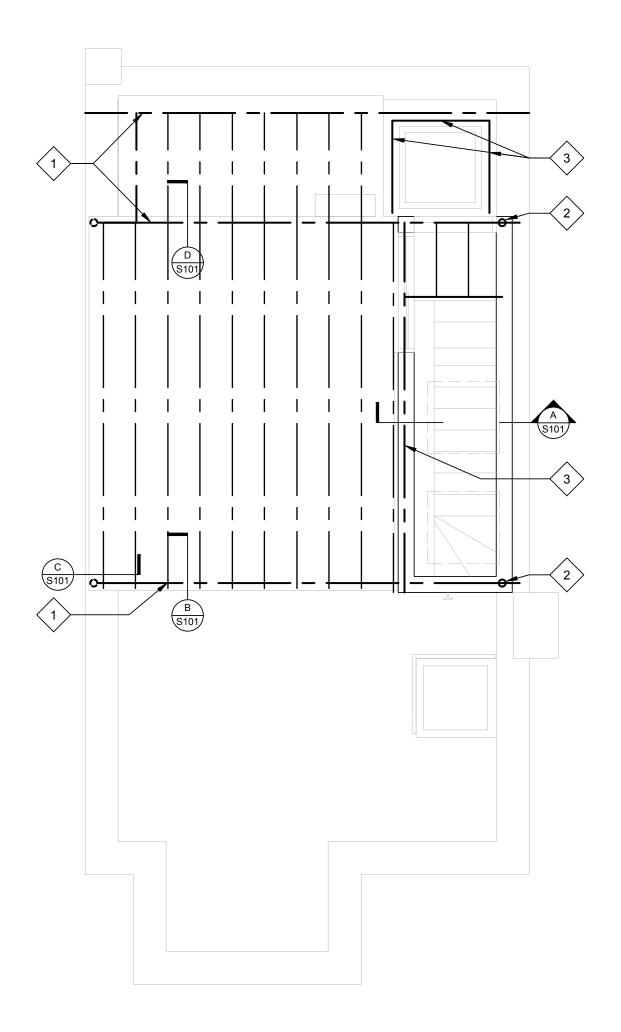

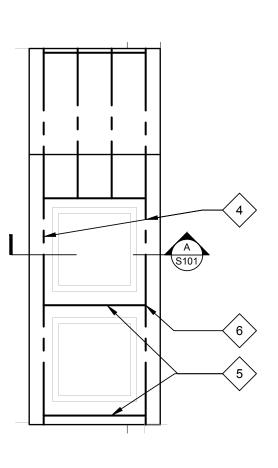

KEY NOTES

W10X22 (BEAM TYP OF 3)


PIPE 3 STANDARD SCHEDULE 40 PIPE (3 1/2 " OD) TYP OF 6

 $\langle 3 \rangle$ (2) 2X12

2X8 @ 16 OC RAFTERS


5 (2) 2X8 BEAM

3 STUDS TYP EACH END OF BEAM

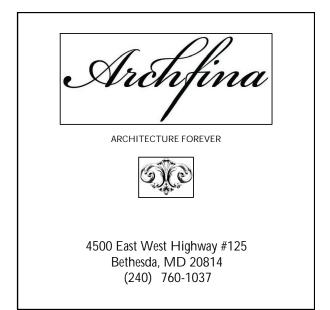

NOTE: Drawing may be printed at reduced scale

DRAFT - NOT FOR CONSTRUCTION

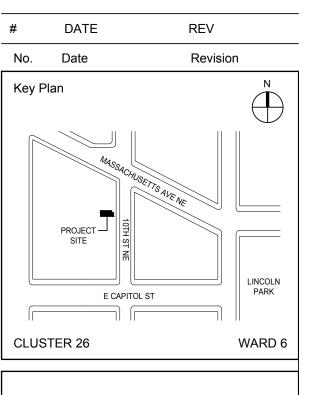

EOR: JAMES GEORGE KONNICK PE AOR: CLAIR M. WHOLEAN AIA LEED AP BD+C

Project No. 2018-001

09/17/2018

ROOF REPLACEMENT WITH GREEN ROOF

Address: 16 10TH ST NE WASHINGTON DC 20002

Drawing Title:

ROOF DECK & ROOF FRAMING PLANS

Drawing No.:

S102.00


Sheets in DOB Set:

16 of 17


Sheets in Contract Set: 16 of 17

ROOF DECK PLAN


UPPER ROOF PLAN

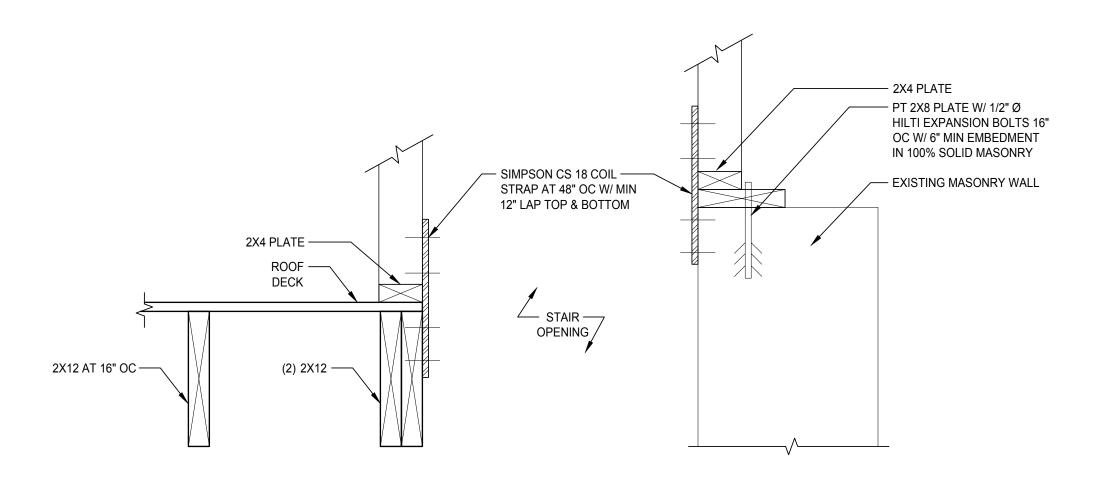



SECTION A 1 1/2" = 1'-0"

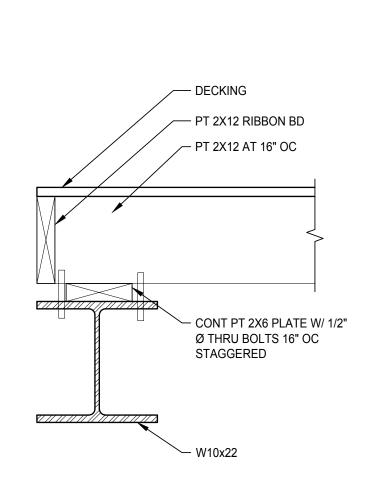



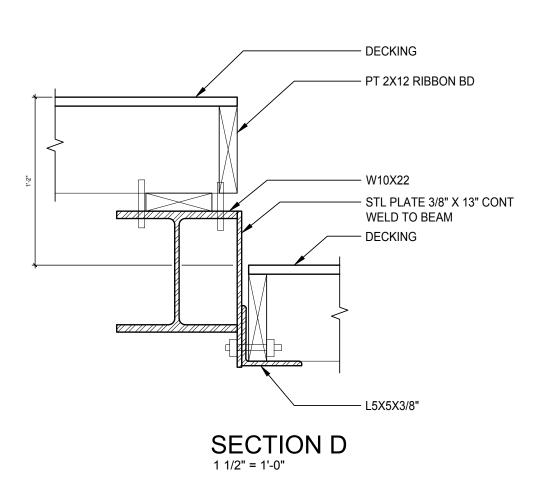

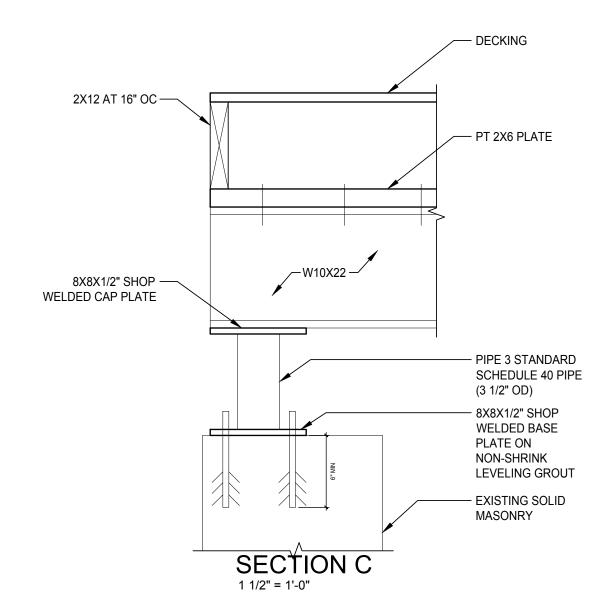

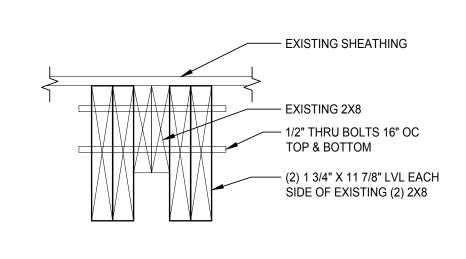






NOTE: Drawing may be printed at reduced scale

DRAFT - NOT FOR CONSTRUCTION

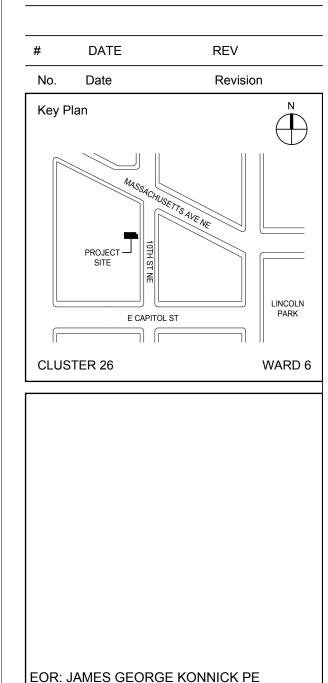

ROOF REPLACEMENT WITH GREEN ROOF

AOR: CLAIR M. WHOLEAN AIA LEED AP BD+C

09/17/2018

Address: 16 10TH ST NE WASHINGTON DC 20002

Drawing Title:
STRUCTURAL DETAILS

Drawing No.:

Project No. 2018-001

S103.00

Sheets in Contract Set: Sh

Sheets in DOB Set: 17 of 17